## **Montgomery County**

## Specification Download Acknowledgement




New Danville	Project # 24-18
Infrastructure Expansion MCCD	PLANS
VENDORS MUST IMMEDIATELY RETU	JRN THIS FORM BY EMAIL: purchasing@mctx.org
Vendor	Responsibilities
stated on cover of document  Vendor must submit 1295 for  Detailed information regarding 1295 can be for Texas Ethics Commission website for 1295: <a href="https://www.ethics.state.tx.us/whatsne">https://www.ethics.state.tx.us/whatsne</a> For completing the 1295:  Contract ID: 5154	tes in accordance with requirements  The with Bid/Proposal found under item 49 in the attached Terms and Conditions.  Ew/elf info form1295.htm
Legal Name of Contracting Company	
Contact Person	
Complete Mailing Address	
Telephone Number	Email Address
Signature	 Date

# CONSTRUCTION PLANS FOR

# 

# WATERLINES, SANITARY SEWER, STORM SEWER, & DETENTION TO SERVE MEADOWBROOK RESIDENTIAL EXPANSION WITHIN MONTGOMERY COUNTY, TEXAS FEBRUARY 2024

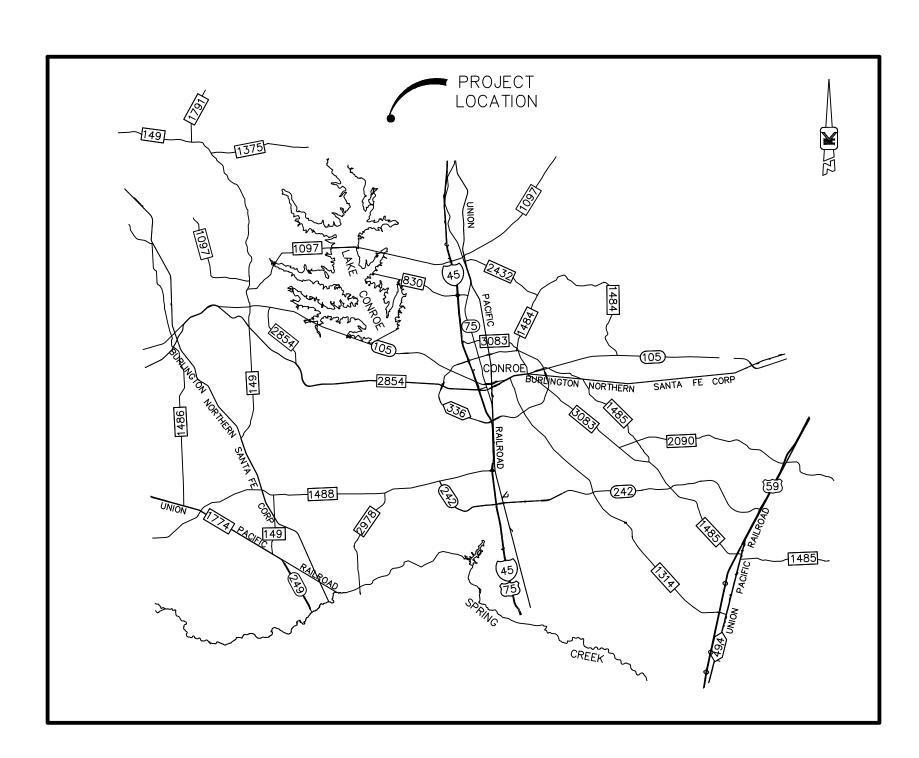


VICINITY MAP (N.T.S.)

PREPARED FOR: TEXAS NEW COMMUNITY ALLIANCE 10951 SHEPARD HILL RD WILLIS, TX 77318

#### SHEET INDEX

- DIMENSION, CLEARING AND EROSION CONTROL PLAN
- PRE DEVELOPED DRAINAGE AREA MAP
- POST DEVELOPED DRAINAGE AREA MAP
- STORM CALCULATIONS
- WATERLINE ALIGNMENT C P&P
- SANITARY ALIGNMENT 1 P&P SANITARY ALIGNMENT 2 P&P
- STORM ALIGNMENT A P&P
- STORM ALIGNMENT B & C P&P
- **GRADING PLAN**
- **DETENTION SECTIONS**
- GENERAL NOTES, WATERLINE & SANITARY SEWER DETAILS
- STORM SEWER & DETENTION POND DETAILS

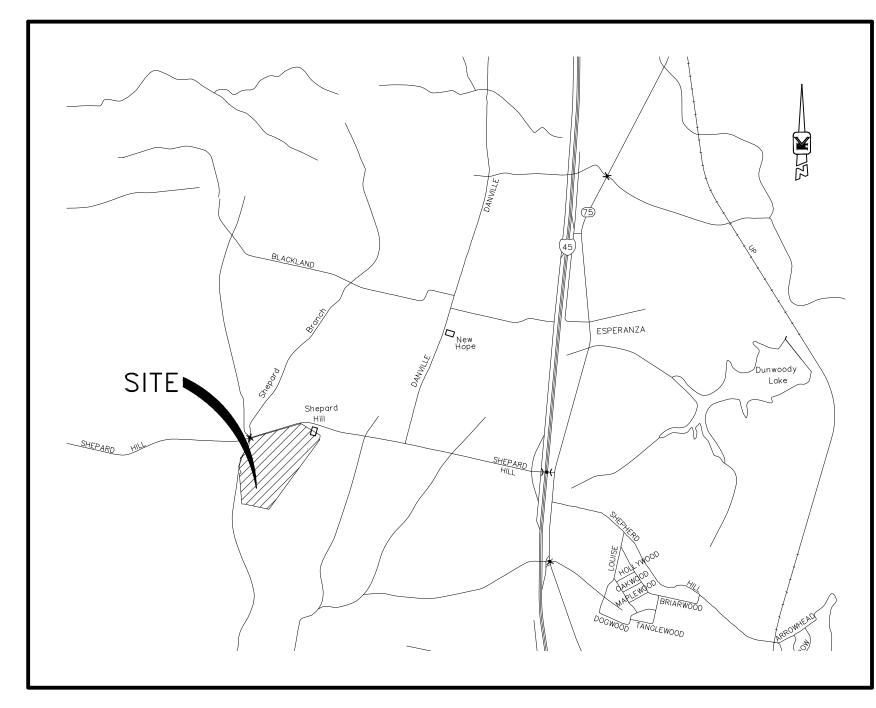


MONTGOMERY COUNTY KEYMAP NO. 96-M (N.T.S.)


ONE-CALL NOTIFICATION SYSTEM CALL BEFORE YOU DIG!! (281)-970-0505 (New Statewide Number) 1-800-545-6005

THE CONTRACTOR SHALL NOTIFY MONTGOMERY COUNTY AND TEXAS COMMISSION ON ENVIRONMENTAL QUALITY 48 HOURS IN ADVANCE OF COMMENCING CONSTRUCTION PREPARED BY




2203 Timberloch Pl., Suite 124 The Woodlands, Texas 77380 T 281.651.2972 www.vogtengineering.com

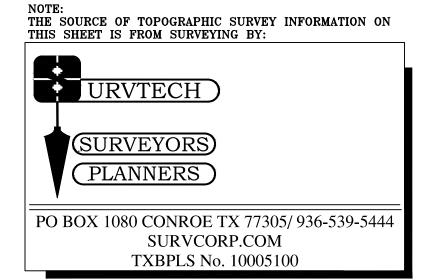


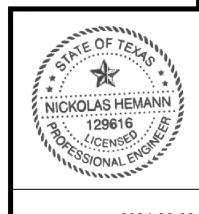



Midrola Henam 2024.02.09 S 13:08:32-06'00'

01 of 17

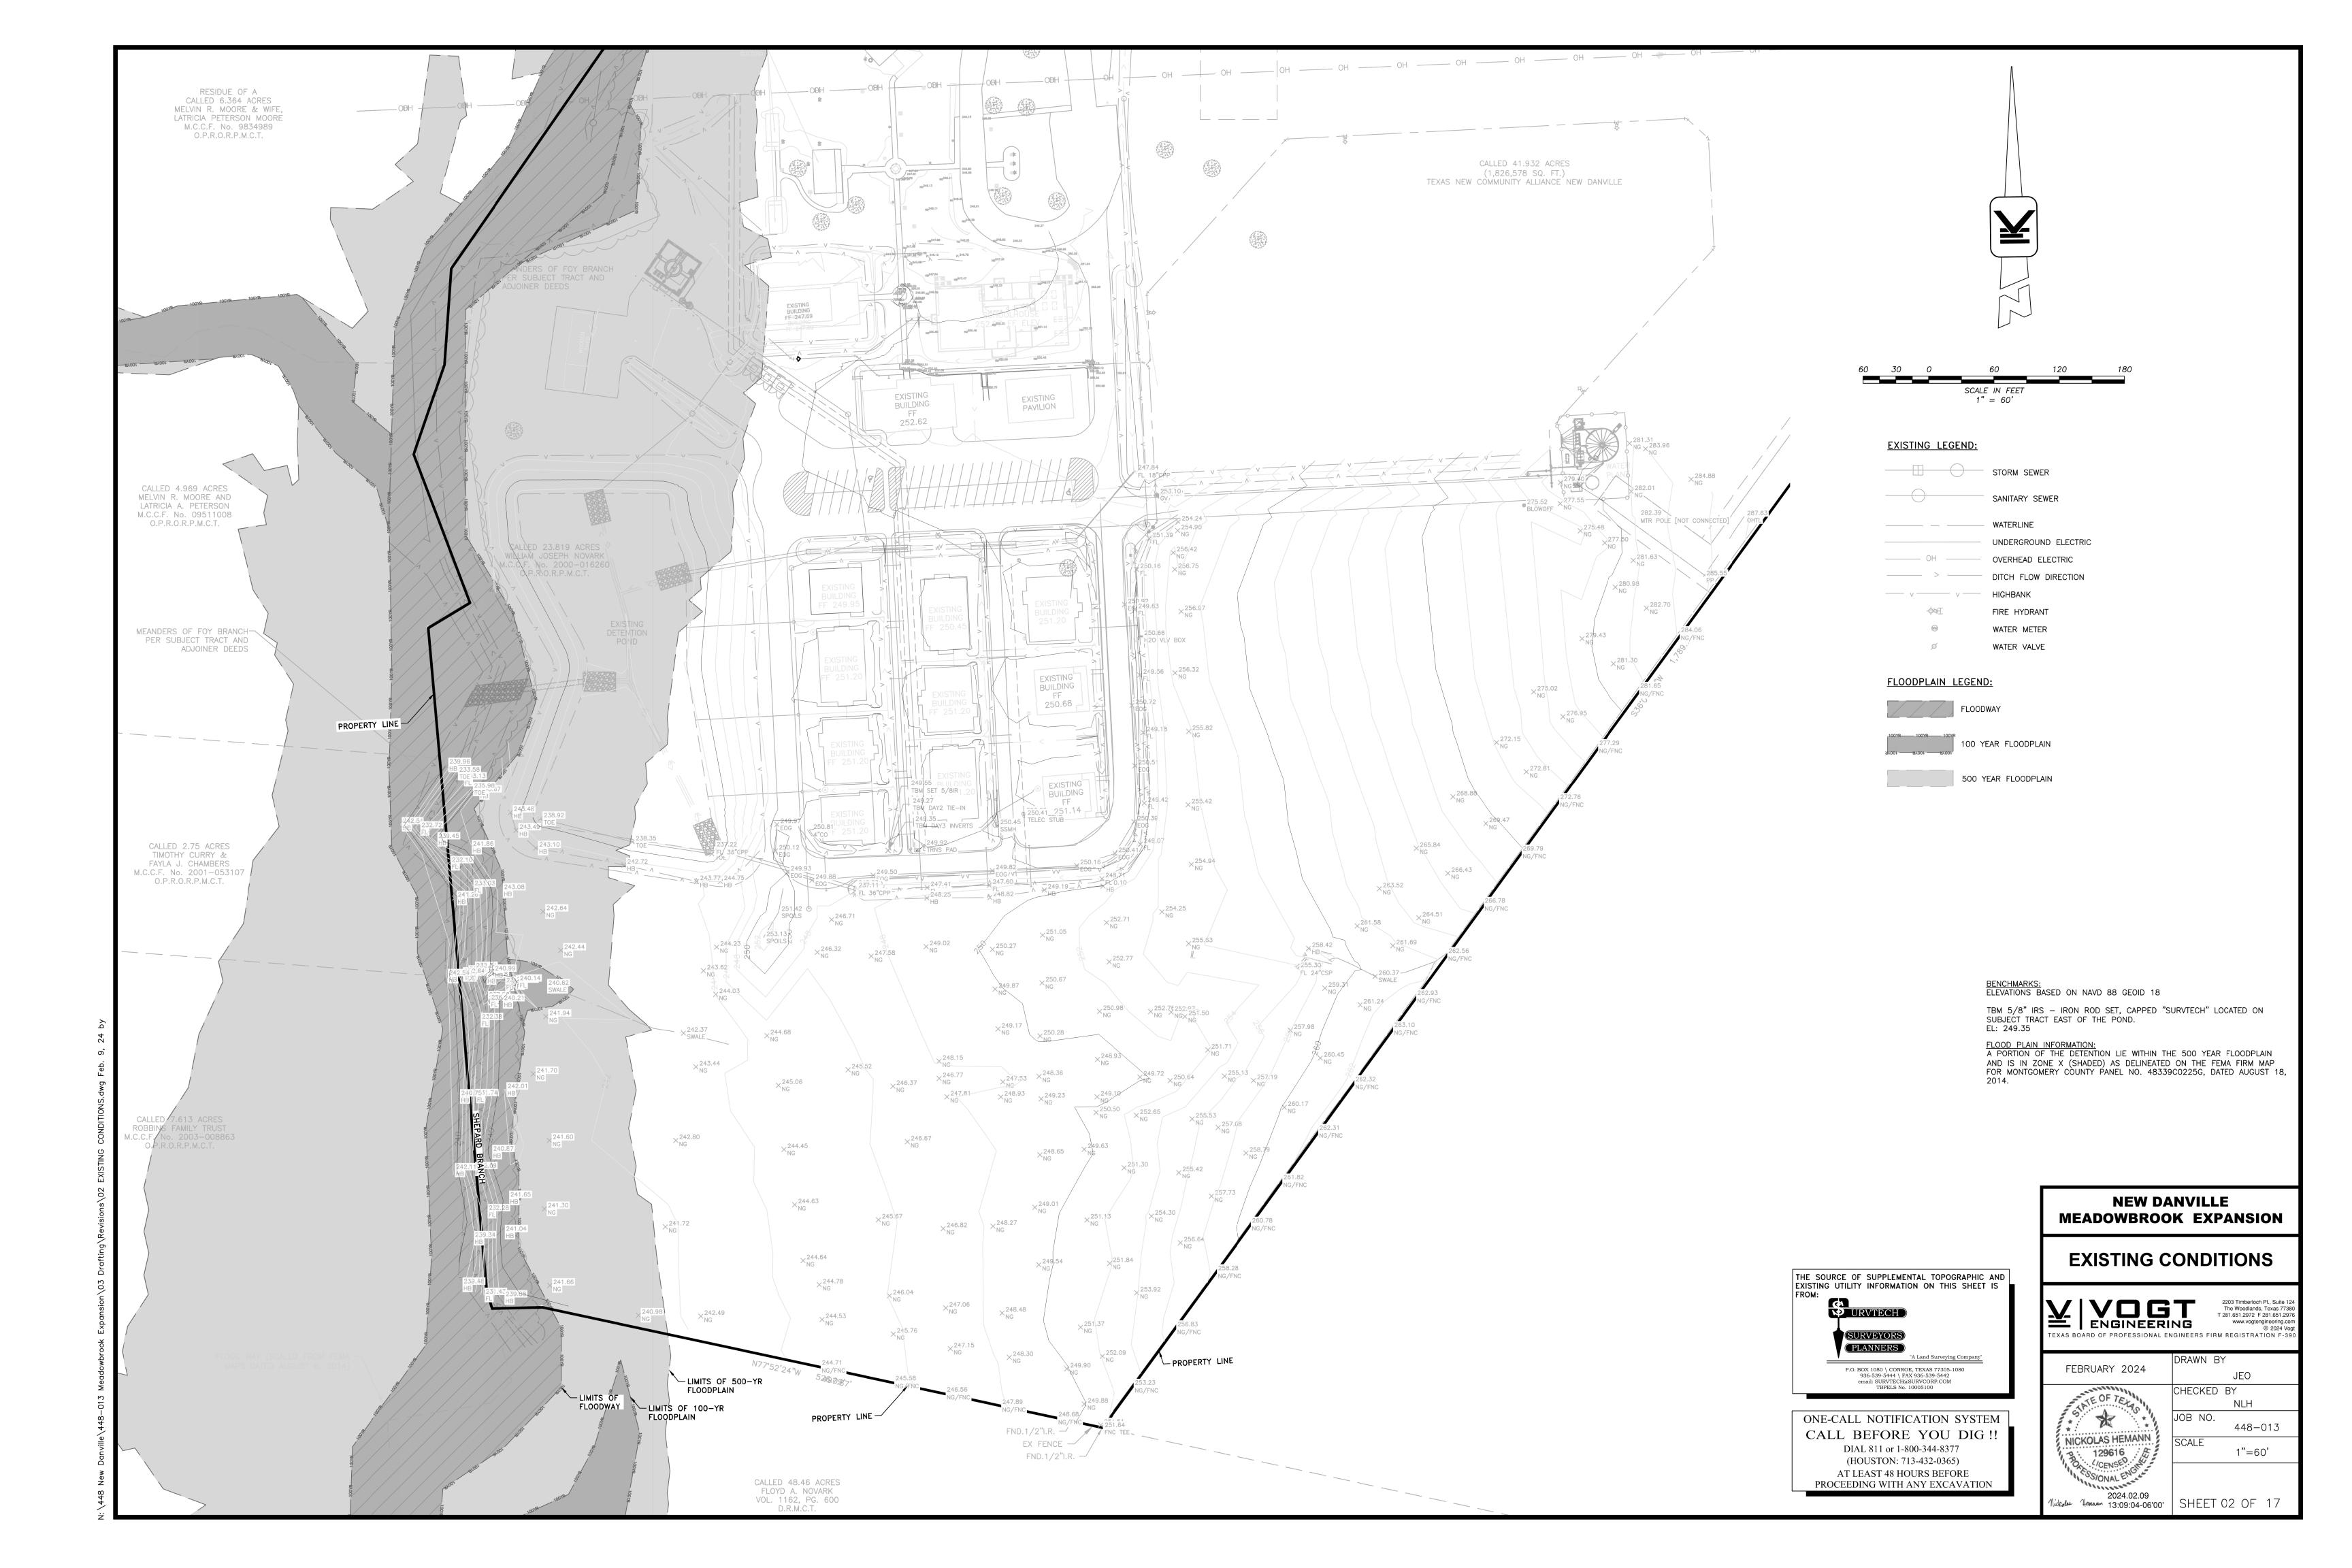

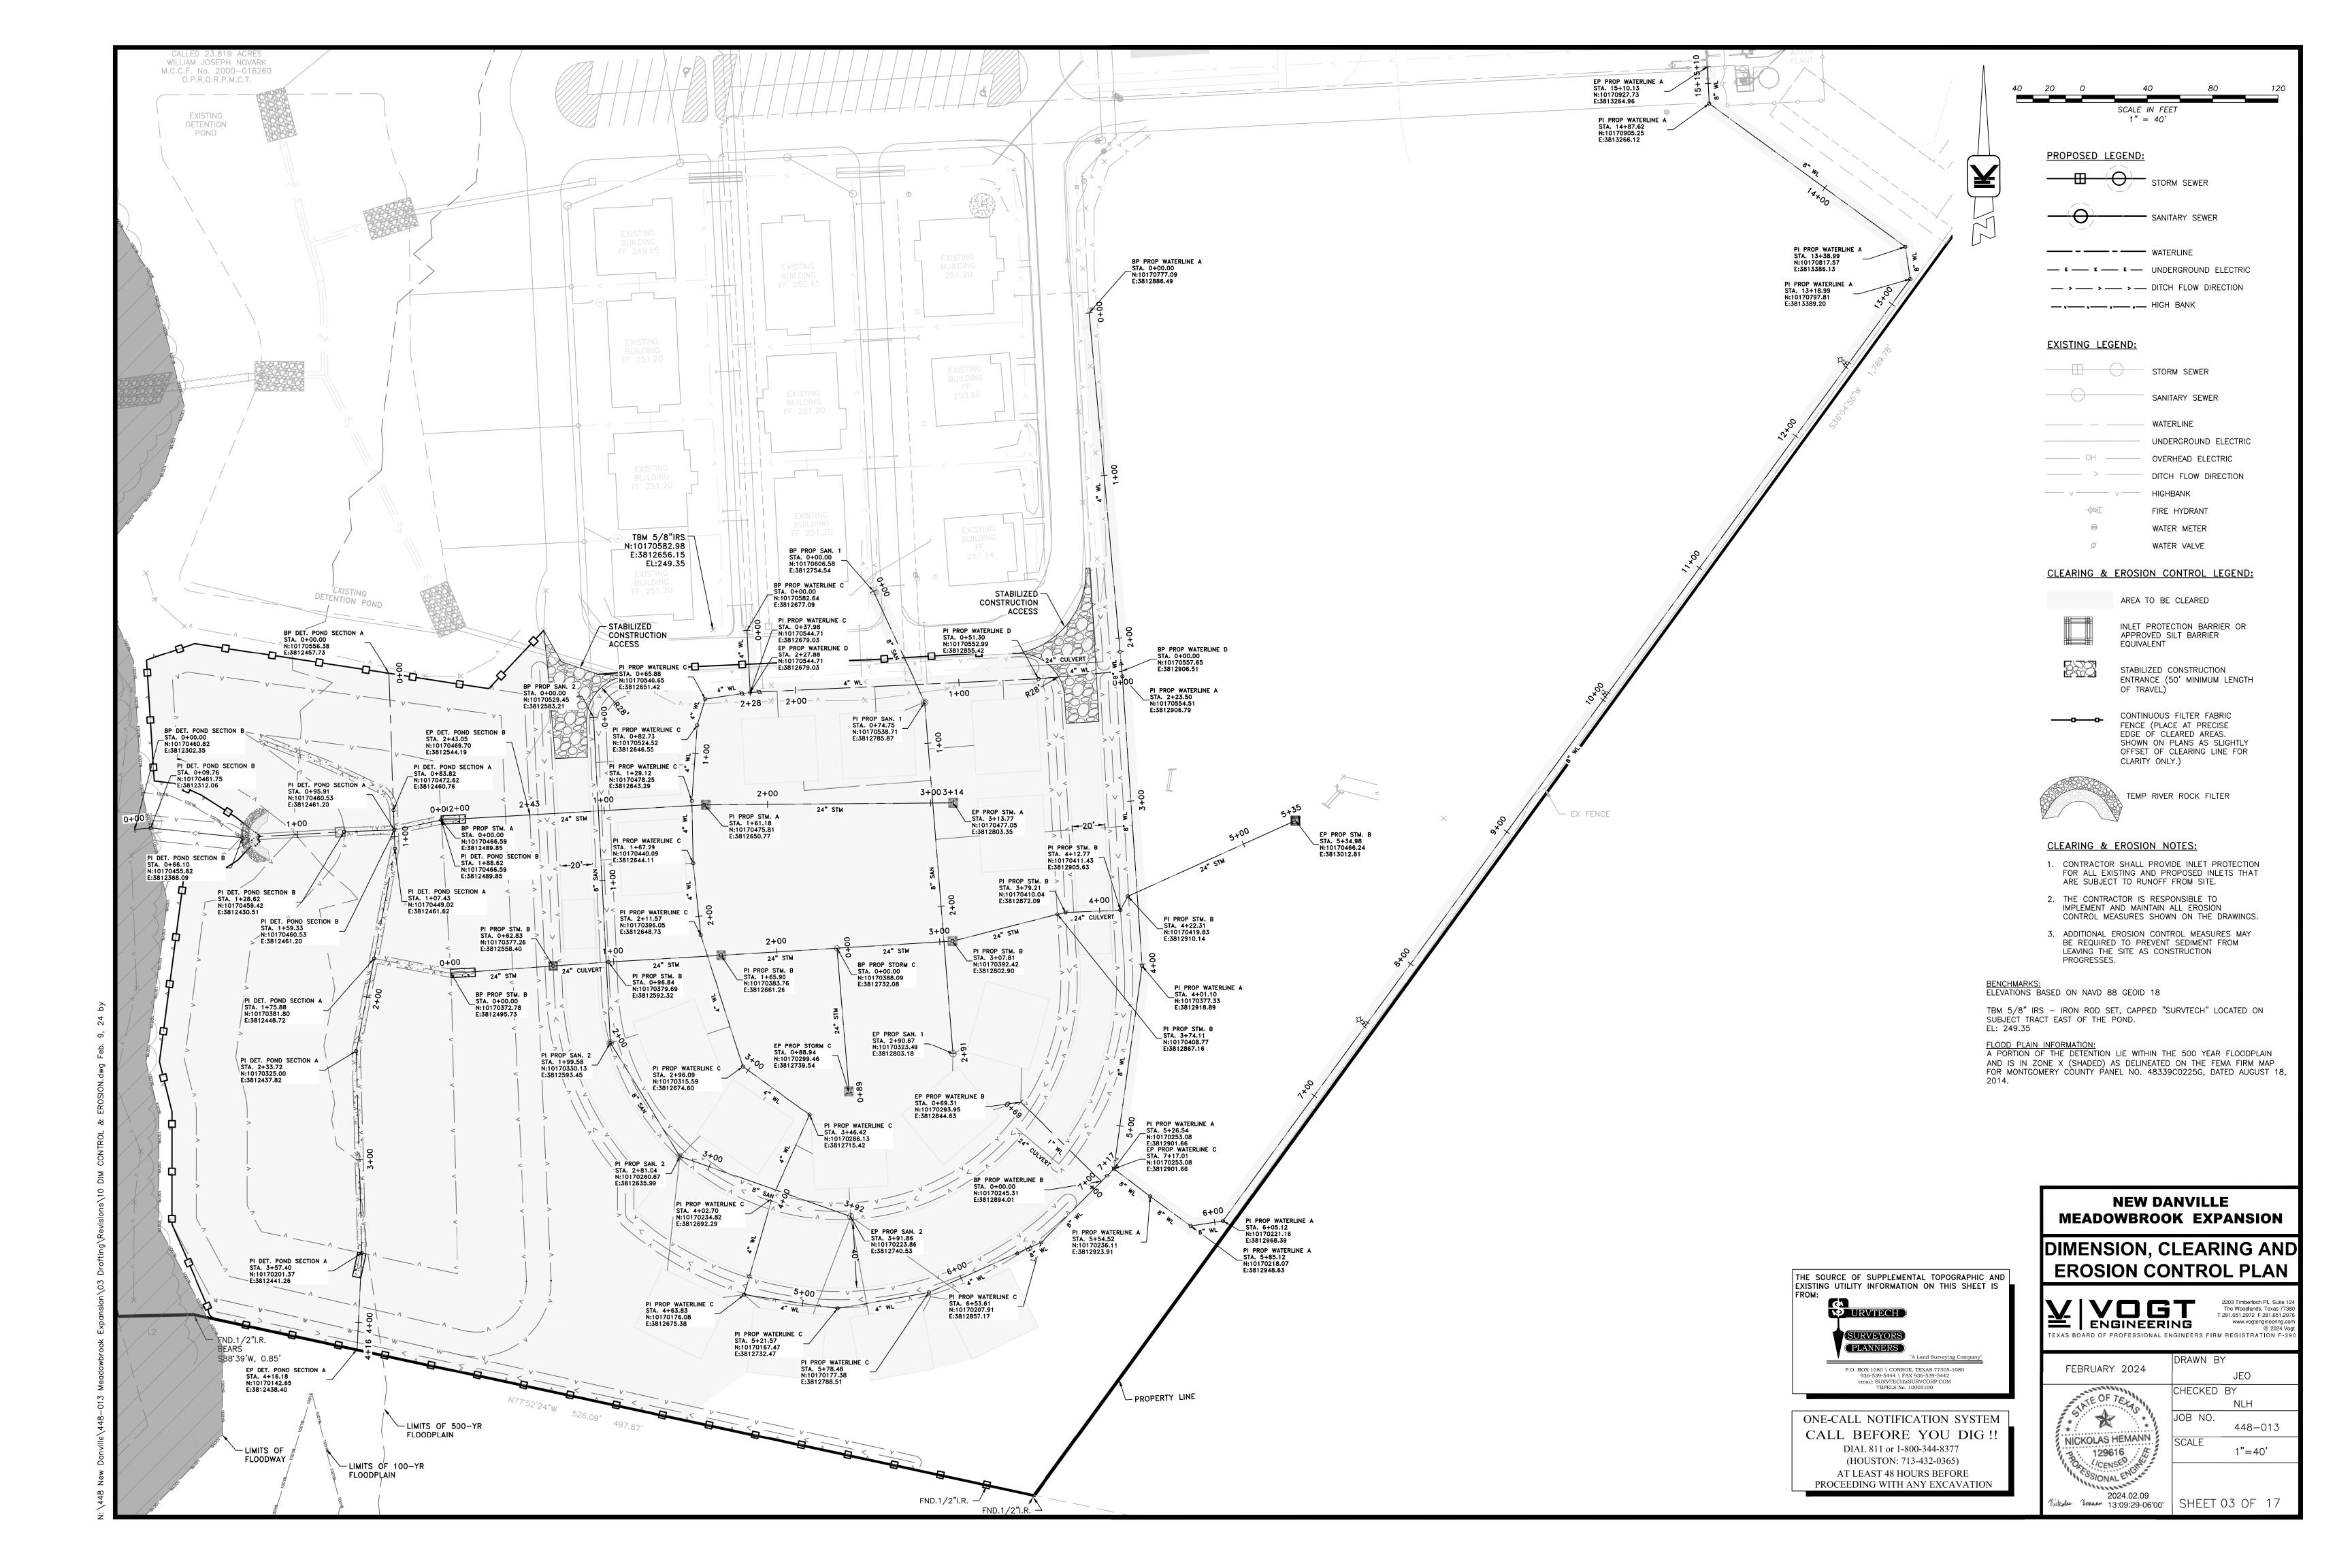

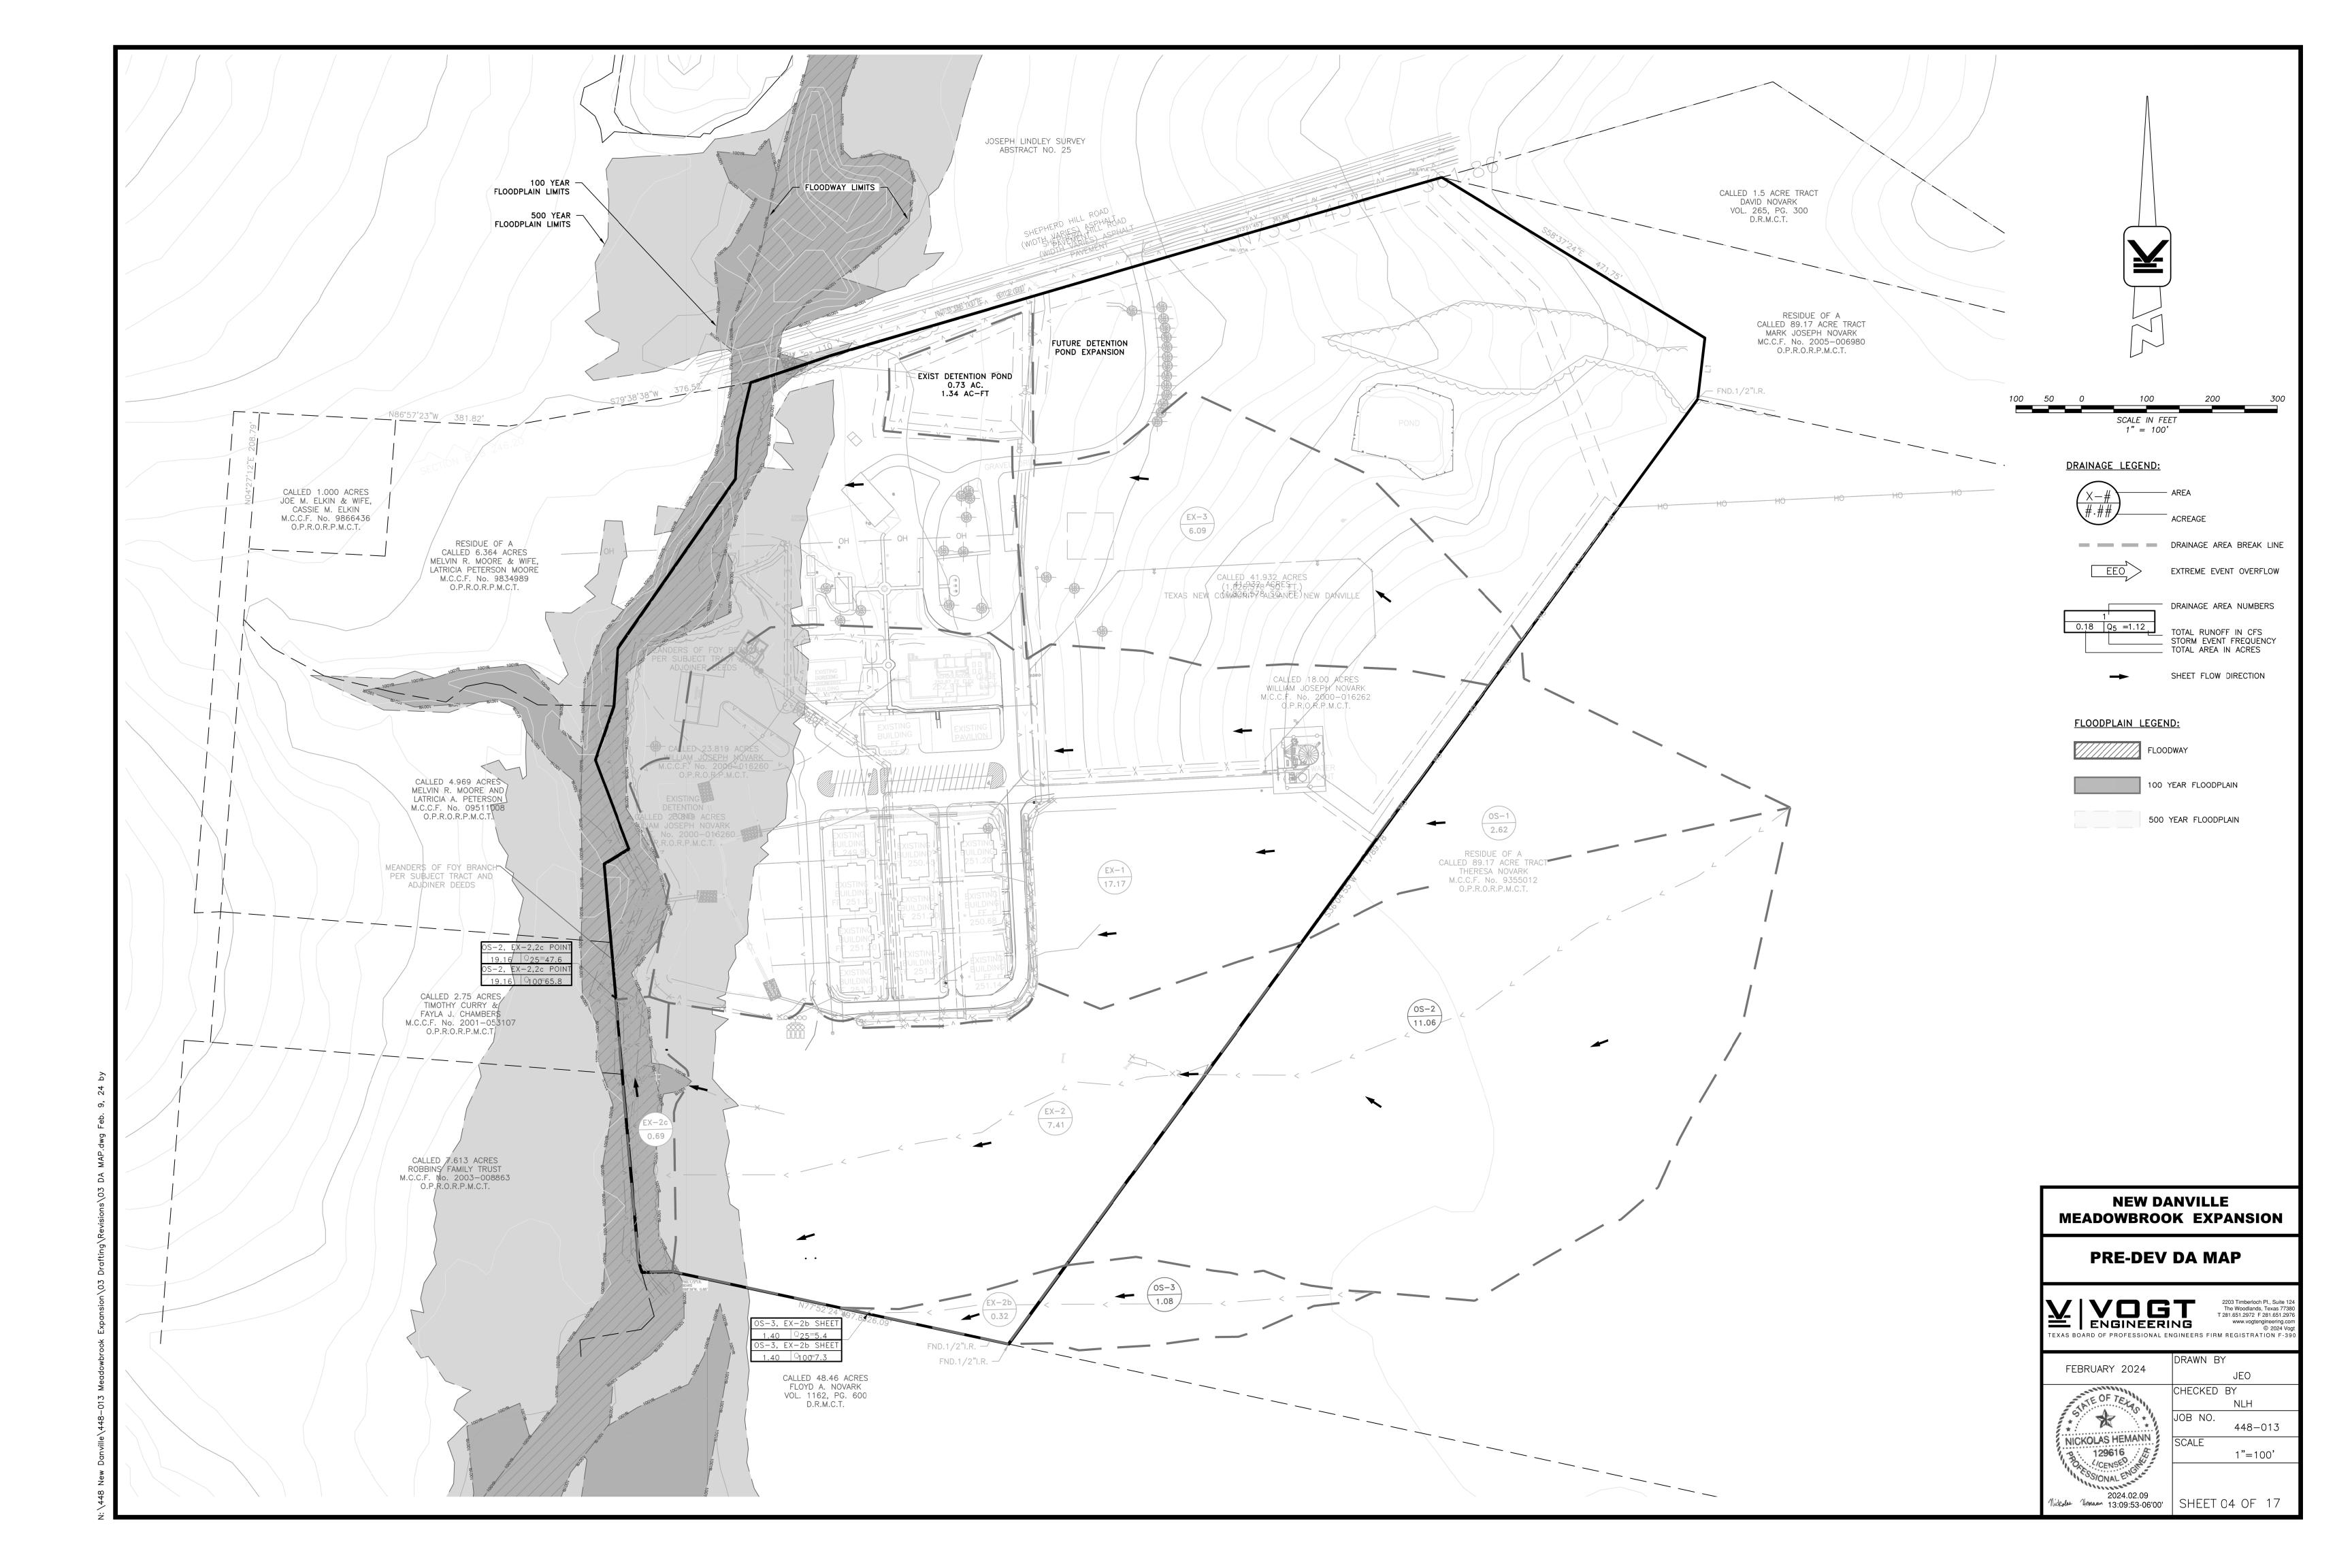

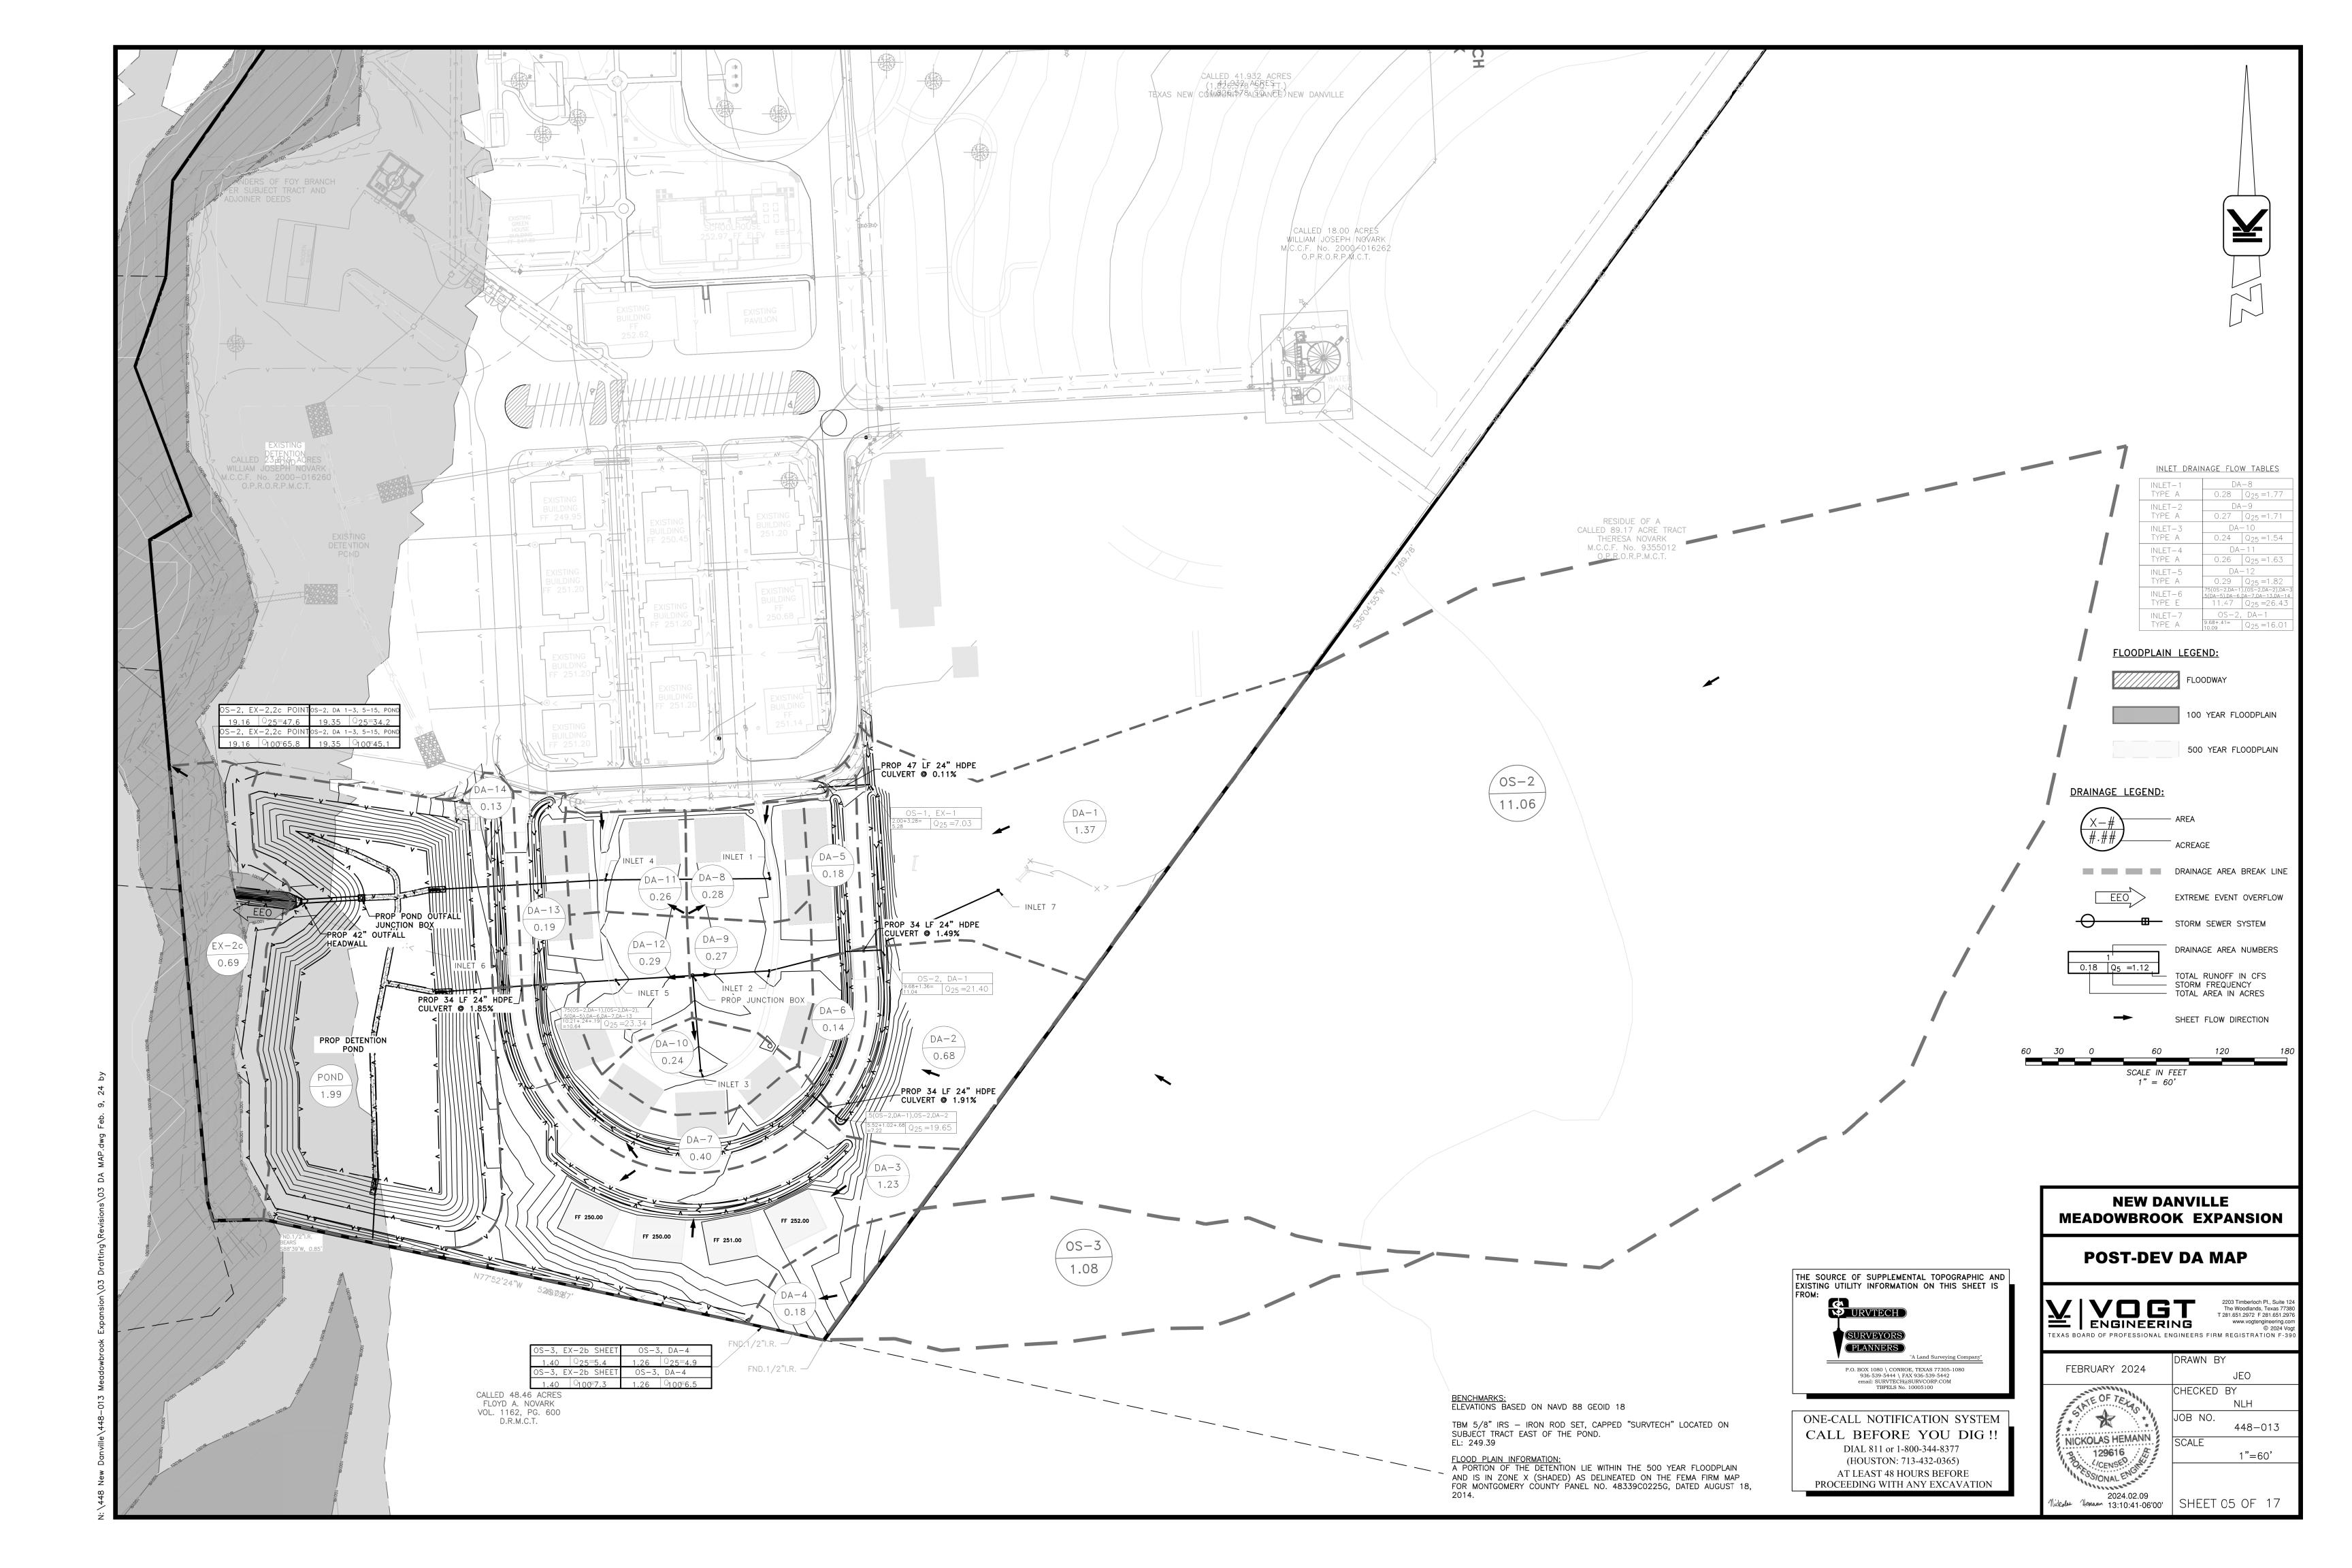

## CULVERT CALCULATIONS

CULVERT ID.	Drainage Areas Designation	Area (Ac)	Runoff Coefficient C	Time of Concentration (min.)	i25 (In./Hr.)	Q25 (cfs)	Length	Number of Culverts	Diam.	Pipe Area (sft.)	Hydraulic Radius (ft.)	Slope %	Manning's n	Fall (ft.)	Flowline Elevation Upstream (ft.)	Flowline Elevation Downstream (ft.)			Elevation of	Hyd. Grad.	Top of Pavement	Top of Bank (ft)
CULVERT 1	OS-1, EX-1	5.28	0.18	21.92	6.72	7.03	47	1	24	3.14	0.50	0.11%	0.013	0.05	248.30	248.25	4.84	0.16	250.41	250.25	251.30	251.1
CULVERT 2	OS-2, DA-1	11.04	0.26	20.97	6.87	21.69	34	1	24	3.14	0.50	1.47%	0.013	0.50	247.30	246.80	9.14	1.43	250.23	248.80	250.00	249.8
CULVERT 3	OS-2, DA-2	7.22	0.30	13.92	8.33	19.85	34	1	24	3.14	0.50	1.91%	0.013	0.65	247.00	246.35	9.51	1.19	249.54	248.35	249.53	249.33
	OS-2, DA-1, DA-2, DA-5,																					
CULVERT 4	DA-6, DA-7, DA-13	10.64	0.32	24.73	6.32	23.67	34	1	24	3.14	0.50	1.85%	0.013	0.63	245.28	244.65	9.50	1.70	248.35	246.65	248.10	247.9

#### RAINFALL INTENSITY-DURATION-FREQUENCY COEFFICIENTS

	10%	4%	1%
Coefficient	(10-year)	(25-year)	(100-ye
e=	0.6752	0.6397	0.5
b=	55.26	56.72	5
d=	7.3	6.12	

### DITCH CALCULATIONS

	DRAINAGE AREA	DRAINAGE	CUMULATIV DRAINAGE AR		10-YR RAINFALL INTENSITY	25-YR RAINFALL INTENSITY	100-YR RAINFALL INTENSITY	10-YR DITCH	25-YR DITCH	100-YR DITCH	10-YR VELOCITY	100-YR VELOCITY	MODELED MAX DITCH		MANNING'S ROUGHNESS COEFFICIENT,	SECTIONAL			HYD.	ТОР	DOWNSTREAM	воттом	UPSTREAM	DOWNSTREAM		DOWNSTREAM	DITCH ACTUAL
	DESIGNATIONS		THROUGH DIT		(in/hr)	(in/hr)	(in/hr)		FLOW Q (cfs)		(ft/s)	(ft/s)	Q (cfs)	(ft)	n	(sf)	(ft/s)				BANK SLOPE	WIDTH (FT)			UPSTREAM FL		LENGTH SLOPE
DITCH 1	OS-2, DA-1	1.36	11.04	0.26	5.79	6.87	8.52	16.38	21.40	30.13	1.36	2.51	37.27	2	0.04	12	3.11	12.65	0.01	12	3.00:1, 3.00:1	0	249.94	250	248.35	247.30	141 0.745%
DITCH 2	OS-2, DA-2	0.68	7.22	0.30	7.02	8.33	10.30	15.05	19.65	27.59	0.80	1.47	33.11	2.5	0.04	18.75	1.77	15.81	0.02	15	3.00:1, 3.00:1	0	250	249.53	247.30	247.00	165 0.182%
DITCH 3	OS-2, DA-3	1.40	0.70	0.48	6.51	7.73	9.56	2.19	2.86	4.02	0.32	0.60	15.61	1.5	0.04	6.75	2.31	9.49	0.02	9	3.00:1, 3.00:1	0	249.53	248.1	247.50	244.65	464 0.614%
DITCH 4	DA-14	0.13	0.13	0.80	9.75	11.65	14.53	1.01	1.33	1.89	0.15	0.28	28.19	1.5	0.04	6.75	4.18	9.49	0.01	9	3.00:1, 3.00:1	0	249.64	248.1	248.25	244.65	181 1.989%
DITCH 5	DA-5	0.16	0.16	0.80	10.88	13.07	16.46	1.39	1.84	2.63	0.07	0.14	86.55	2.5	0.04	18.75	4.62	15.81	0.01	15	3.00:1, 3.00:1	0	249.94	250	248.51	246.80	139 1.230%
DITCH 6	DA-6	0.14	10.21	0.16	5.46	6.48	8.05	8.72	11.41	16.09	0.30	0.56	78.36	3.1	0.04	28.83	2.72	19.61	0.01	18.60	3.00:1, 3.00:1	0	250	249.53	246.80	246.35	140 0.321%
DITCH 7	DA-7	0.40	10.64	0.32	5.32	6.32	7.86	17.84	23.34	32.94	0.87	1.60	48.44	2.62	0.04	20.59	2.35	16.57	0.02	15.72	3.00:1, 3.00:1	0	249.53	248.1	246.35	245.28	357 0.300%
DITCH 8	DA-13	0.17	0.17	0.80	9.30	11.10	13.80	1.27	1.66	2.35	0.06	0.11	109	2.62	0.04	20.59	5.29	16.57	0.01	15.72	3.00:1, 3.00:1	0	249.64	248.1	247.93	245.28	174 1.523%

## STORM SEWER CALCULATIONS

PR	DJECT:	NEW D	ANVILLE																	b =	54.09		
JC	B NO.:	448-013	3												DE	SIGN STORM	1:	5 YR		d =	8.34	AS PER	TXDOT
	BY:	Vogt Er	ngineeri	ng											HGL	STARTING EI	EVATION:	TOP OF PIPE	Ē	e =	0.7051	DRAINAGI	E CRITERIA
																				Cf =	1		
																				ELEVATIO	N OF HYD.		
						TIME		SUM							FLOWLINE	ELEVATIONS				GR	AD.	CRITICAL E	ELEVATION
						OF		OF					DESIGN	DESIGN			ACTUAL	HYDRAULIC					
DRAINAGE			AREA	SUM		CONC	INTENSITY	FLOWS	REACH	DIA.	SLOPE	MANNING'S	VELOCITY	CAPACITY	UpSTREAM	DnSTREAM	VELOCITY	GRADIENT	CHANGE	UpSTREAM	DnSTREAM	UpSTREAM	DnSTREAM
AREA	FROM	TO	(Acres)	OF A	С	(min)	I (in/hr)	(CFS)	LENGTH	(IN)	(%)	(η )	(ft/s)	(CFS)	(FT)	(FT)	V (ft/s)	(%)	IN HEAD	(FT)	(FT)	(FT)	(FT)
DA-8	A-2	A-1	0.28	0.28	0.80	10.00	6.95	1.56	152	24	0.26%	0.013	3.68	11.57	241.18	240.78	0.50	0.005%	0.01	236.56	236.55	249.66	249.71
DA-11	A-1	OUT	0.26	0.54	0.80	15.11	5.85	2.53	162	24	0.26%	0.013	3.68	11.57	234.95	234.53	0.80	0.012%	0.02	236.55	236.53	249.71	0.00
					,																		
DA-1	B-6	B-5	0.41	10.09	0.21	20.03	5.11	10.83	113	24	0.26%	0.013	3.68	11.57	247.59	247.00	3.45	0.228%	0.26	237.76	237.50	254.67	249.30
DA-5	B-5	B-4	0.16	2.85	0.27	20.97	5.00	3.90	66	24	0.26%	0.013	3.68	11.57	246.80	246.63	1.24	0.029%	0.02	237.50	237.48	249.30	249.66
DA-9	B-4	B-3	0.27	3.12	0.32	21.86	4.89	4.87	71	24	0.26%	0.013	3.68	11.57	241.93	241.75	1.55	0.046%	0.03	237.48	237.45	249.66	251.50
																			_				
DA-10	C-1	B-3	0.24	0.24	0.80	10.00	6.95	1.34	89	24	0.26%	0.013	3.68	11.57	243.35	243.12	0.43	0.003%	0.00	237.45	237.45	249.50	251.50
DA-9	B-3	B-2	0.00	3.36	0.35	22.62	4.81	5.71	71	24	0.26%	0.013	3.68	11.57	241.75	241.56	1.82	0.063%	0.04	237.45	237.41	251.50	249.71
DA-12	B-2	B-1	0.29	3.65	0.39	23.27	4.74	6.73	103	24	0.26%	0.013	3.68	11.57	237.93	237.66	2.14	0.088%	0.09	237.41	237.32	249.71	244.65
DA-14	B-1	OUT	0.13	15.12	0.35	24.07	4.65	24.51	63	24	0.26%	0.013	3.68	11.57	234.74	234.58	7.80	1.167%	0.74	237.32	236.58	244.65	0.00

### STORM SEWER CALCULATIONS

PR	DJECT:	NEW D	ANVILLE																	b =	56.68		
JC	B NO.:	448-01	3													DESIG	N STORM:	100 YR		d =		AS PER	RTXDOT
	BY: Vogt Engineering HGL STARTING ELEVATION: TOP OF PIPE e = 0											0.5857	DRAINAG	E CRITERIA									
	Cf = 1												1.25										
																				ELEVATIO	N OF HYD.		
						TIME		SUM							FLOWLINE I	ELEVATIONS				GR	AD.	CRITICAL	ELEVATION
						OF		OF					DESIGN	DESIGN			ACTUAL	HYDRAULIC					
DRAINAGE			AREA	SUM		CONC	INTENSITY	FLOWS	REACH	DIA.	SLOPE	MANNING'S	VELOCITY	CAPACITY	UpSTREAM	DnSTREAM	<b>VELOCITY</b>	GRADIENT	CHANGE	UpSTREAM	DnSTREAM	UpSTREAM	DnSTREAM
AREA	FROM	TO	(Acres)	OF A	С	(min)	l (in/hr)	(CFS)	LENGTH	(IN)	(%)	(η )	(ft/s)	(CFS)	(FT)	(FT)	V (ft/s)	(%)	IN HEAD	(FT)	(FT)	(FT)	(FT)
DA-8	A-2	A-1	0.28	0.28	0.80	10.00	11.86	3.32	152	24	0.26%	0.013	3.68	11.57	241.18	240.78	1.06	0.021%	0.03	236.67	236.64	249.66	249.71
DA-11	A-1	OUT	0.26	0.54	0.80	12.40	10.84	5.85	162	24	0.26%	0.013	3.68	11.57	234.95	234.53	1.86	0.067%	0.11	236.64	236.53	249.71	0.00
																							_
DA-1	B-6	B-5	0.41	10.09	0.21	10.00	11.86	31.40	113	24	0.26%	0.013	3.68	11.57	247.29	247.00	10.00	1.916%	2.17	247.33	245.16	254.67	249.30
																							_
DA-5	B-5	B-4	0.16	2.85	0.27	10.00	11.86	11.55	66	24	0.26%	0.013	3.68	11.57	246.80	246.63	3.68	0.259%	0.17	245.16	244.99	249.30	249.66
DA-9	B-4	B-3	0.27	3.12	0.32	10.30	11.71	14.58	71	24	0.26%	0.013	3.68	11.57	241.93	241.75	4.64	0.413%	0.29	244.99	244.70	249.66	251.50
																							_
DA-10	C-1	B-3	0.24	0.24	0.80	10.00	11.86	2.85	89	24	0.26%	0.013	3.68	11.57	243.35	243.12	0.91	0.016%	0.01	243.47	243.45	249.50	251.50
						- 2					10	,	,					,					_
DA-9	B-3	B-2	0.00	3.36	0.35	10.55	11.60	17.22	71	24	0.26%	0.013	3.68	11.57	241.75	241.56	5.48	0.576%	0.41	244.70	244.29	251.50	249.71
DA-12	B-2	B-1	0.29	3.65	0.39	10.77	11.50	20.41	103	24	0.26%	0.013	3.68	11.57	237.93	237.66	6.50	0.809%	0.83	244.29	243.45	249.71	244.65
DA-14	B-1	OUT	0.13	15.12	0.35	11.03	11.39	74.92	63	24	0.26%	0.013	3.68	11.57	234.74	234.58	23.85	10.909%	6.87	243.45	236.58	244.65	0.00

BENCHMARKS: ELEVATIONS BASED ON NAVD 88 GEOID 18

TBM 5/8" IRS — IRON ROD SET, CAPPED "SURVTECH" LOCATED ON SUBJECT TRACT EAST OF THE POND. EL: 249.35

FLOOD PLAIN INFORMATION:
A PORTION OF THE DETENTION LIE WITHIN THE 500 YEAR FLOODPLAIN AND IS IN ZONE X (SHADED) AS DELINEATED ON THE FEMA FIRM MAP FOR MONTGOMERY COUNTY PANEL NO. 48339C0225G, DATED AUGUST 18,

> **NEW DANVILLE MEADOWBROOK EXPANSION**

STORM CALCULATIONS



PLANNERS P.O. BOX 1080 \ CONROE, TEXAS 77305-1080 936-539-5444 \ FAX 936-539-5442 email: SURVTECH@SURVCORP.COM TBPELS No. 10005100

ONE-CALL NOTIFICATION SYSTEM CALL BEFORE YOU DIG!! DIAL 811 or 1-800-344-8377 (HOUSTON: 713-432-0365) AT LEAST 48 HOURS BEFORE PROCEEDING WITH ANY EXCAVATION

THE SOURCE OF SUPPLEMENTAL TOPOGRAPHIC AND EXISTING UTILITY INFORMATION ON THIS SHEET IS


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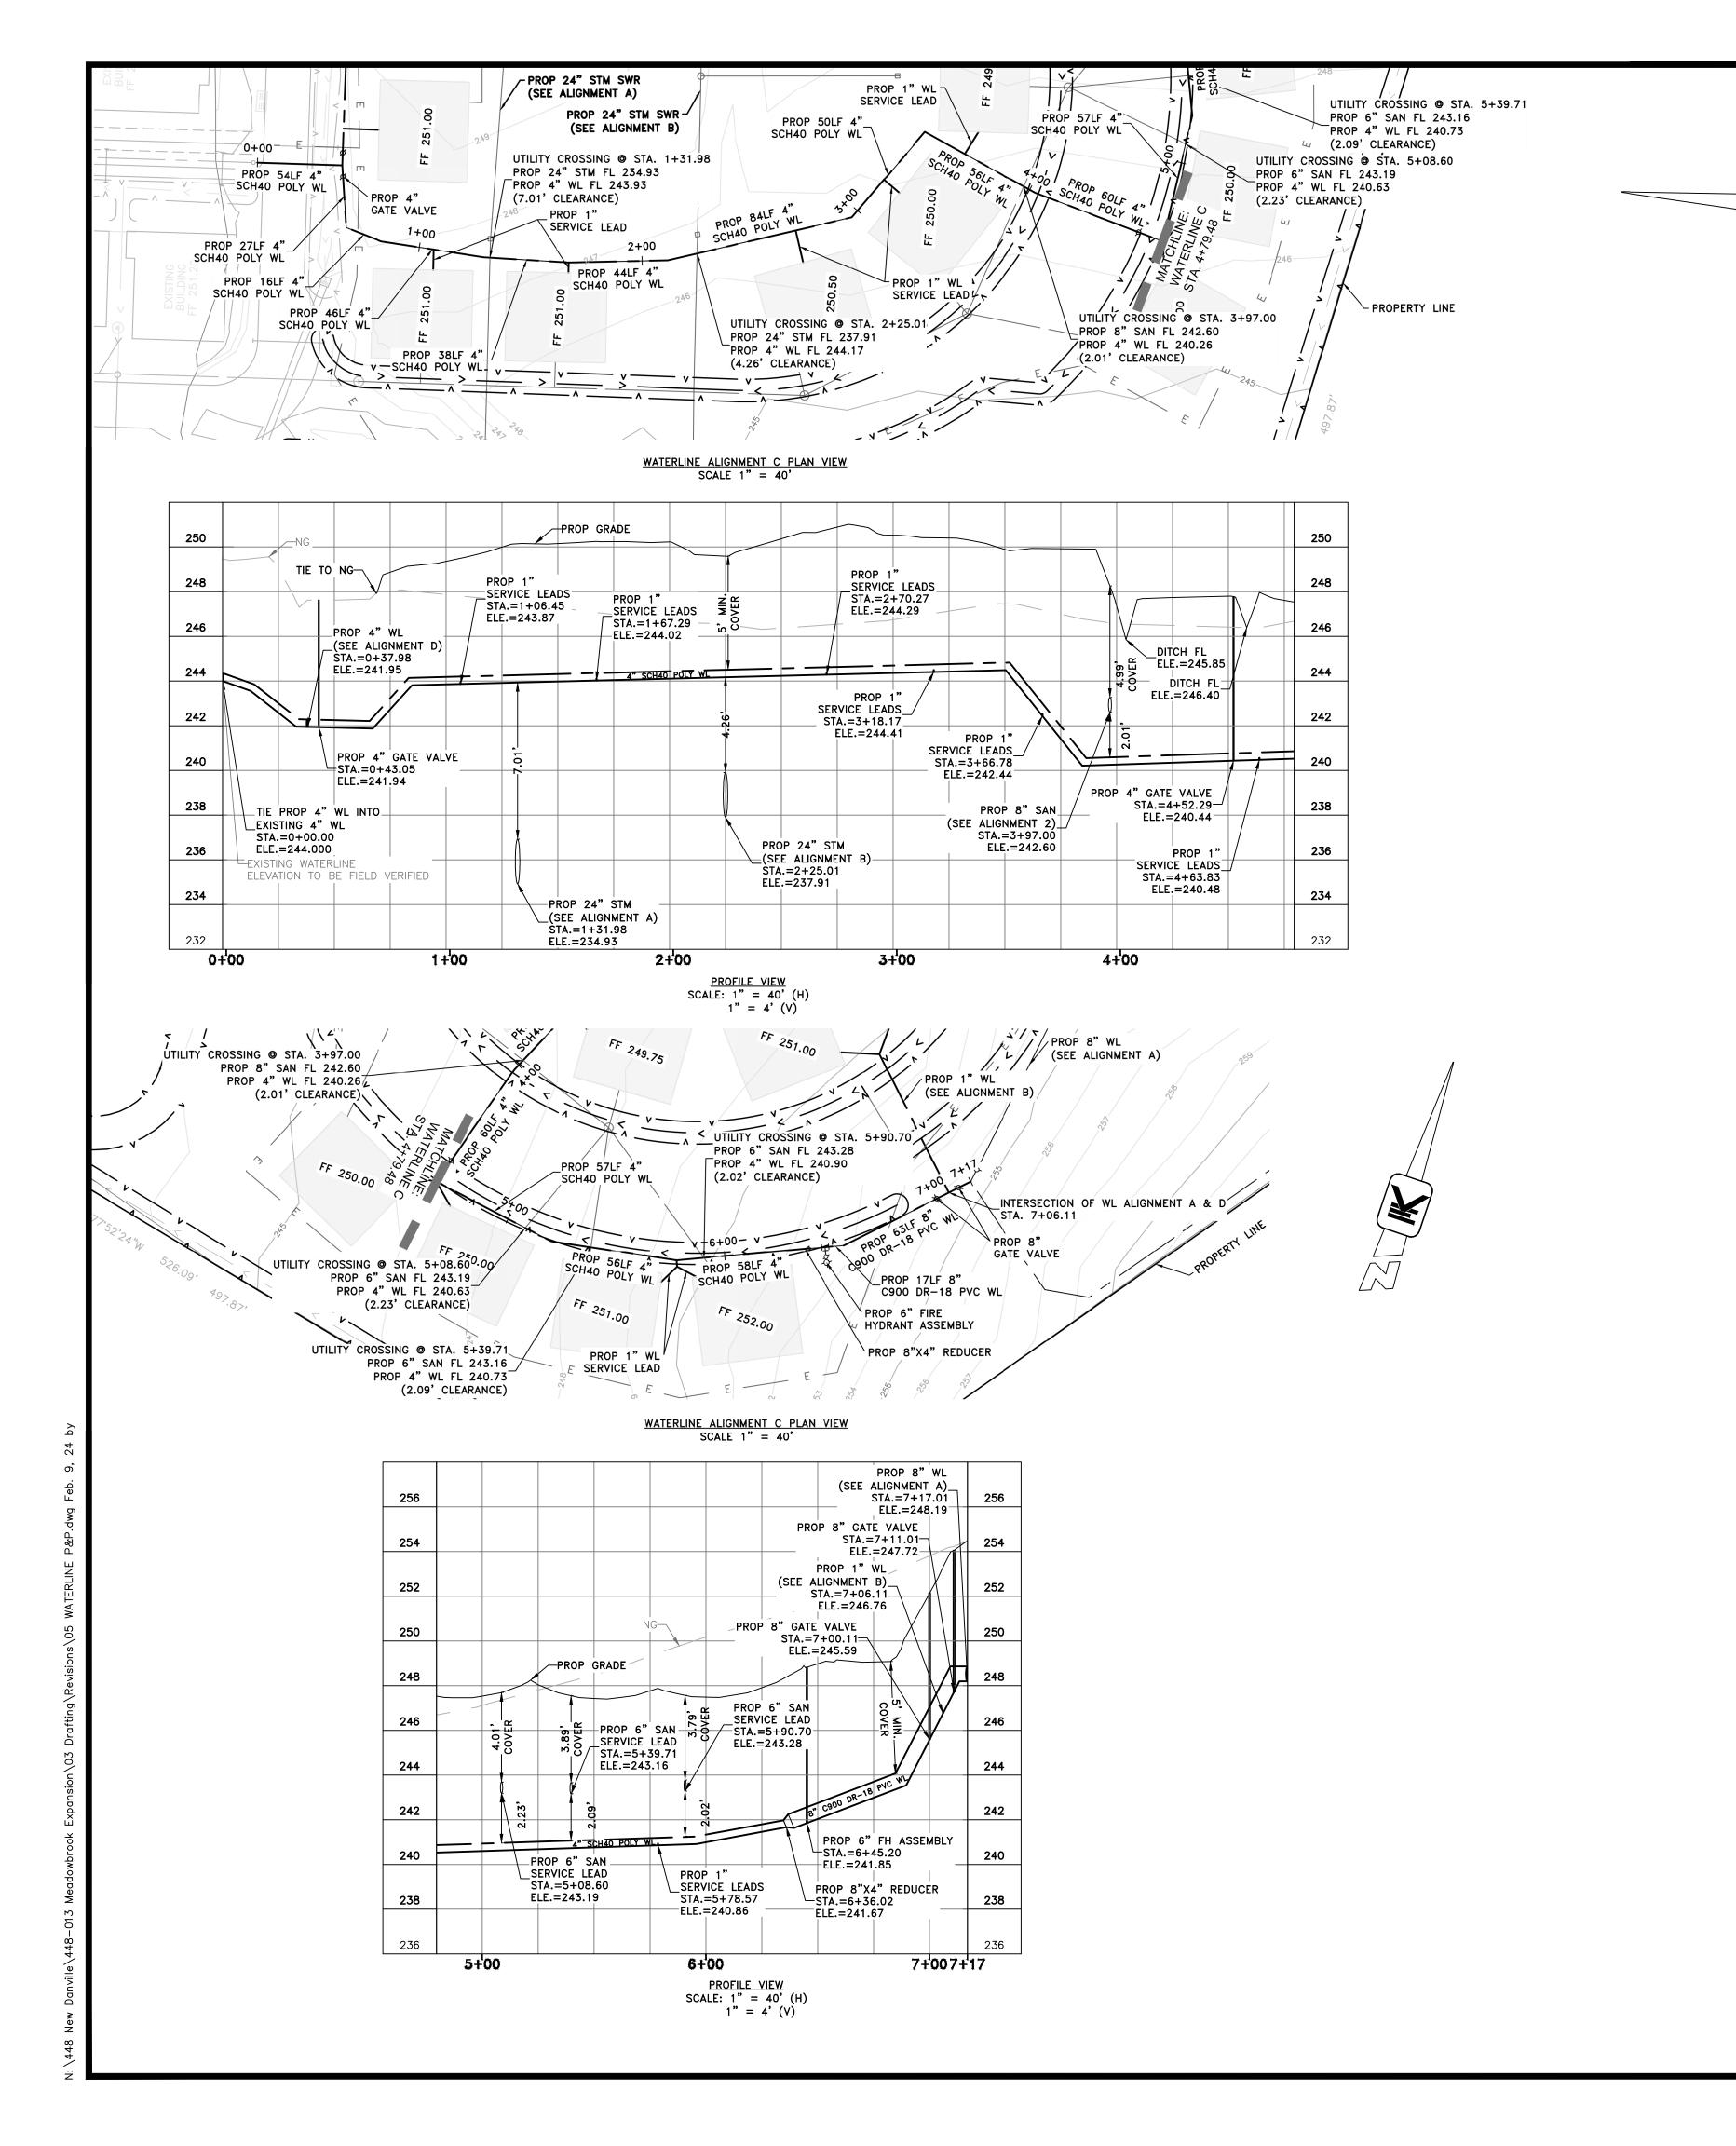
FEBRUARY 2024 NICKOLAS HEMANN 129616


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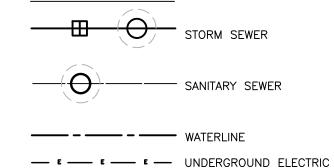
2203 Timberloch Pl., Suite 124 The Woodlands, Texas 77380 T 281.651.2972 F 281.651.2976






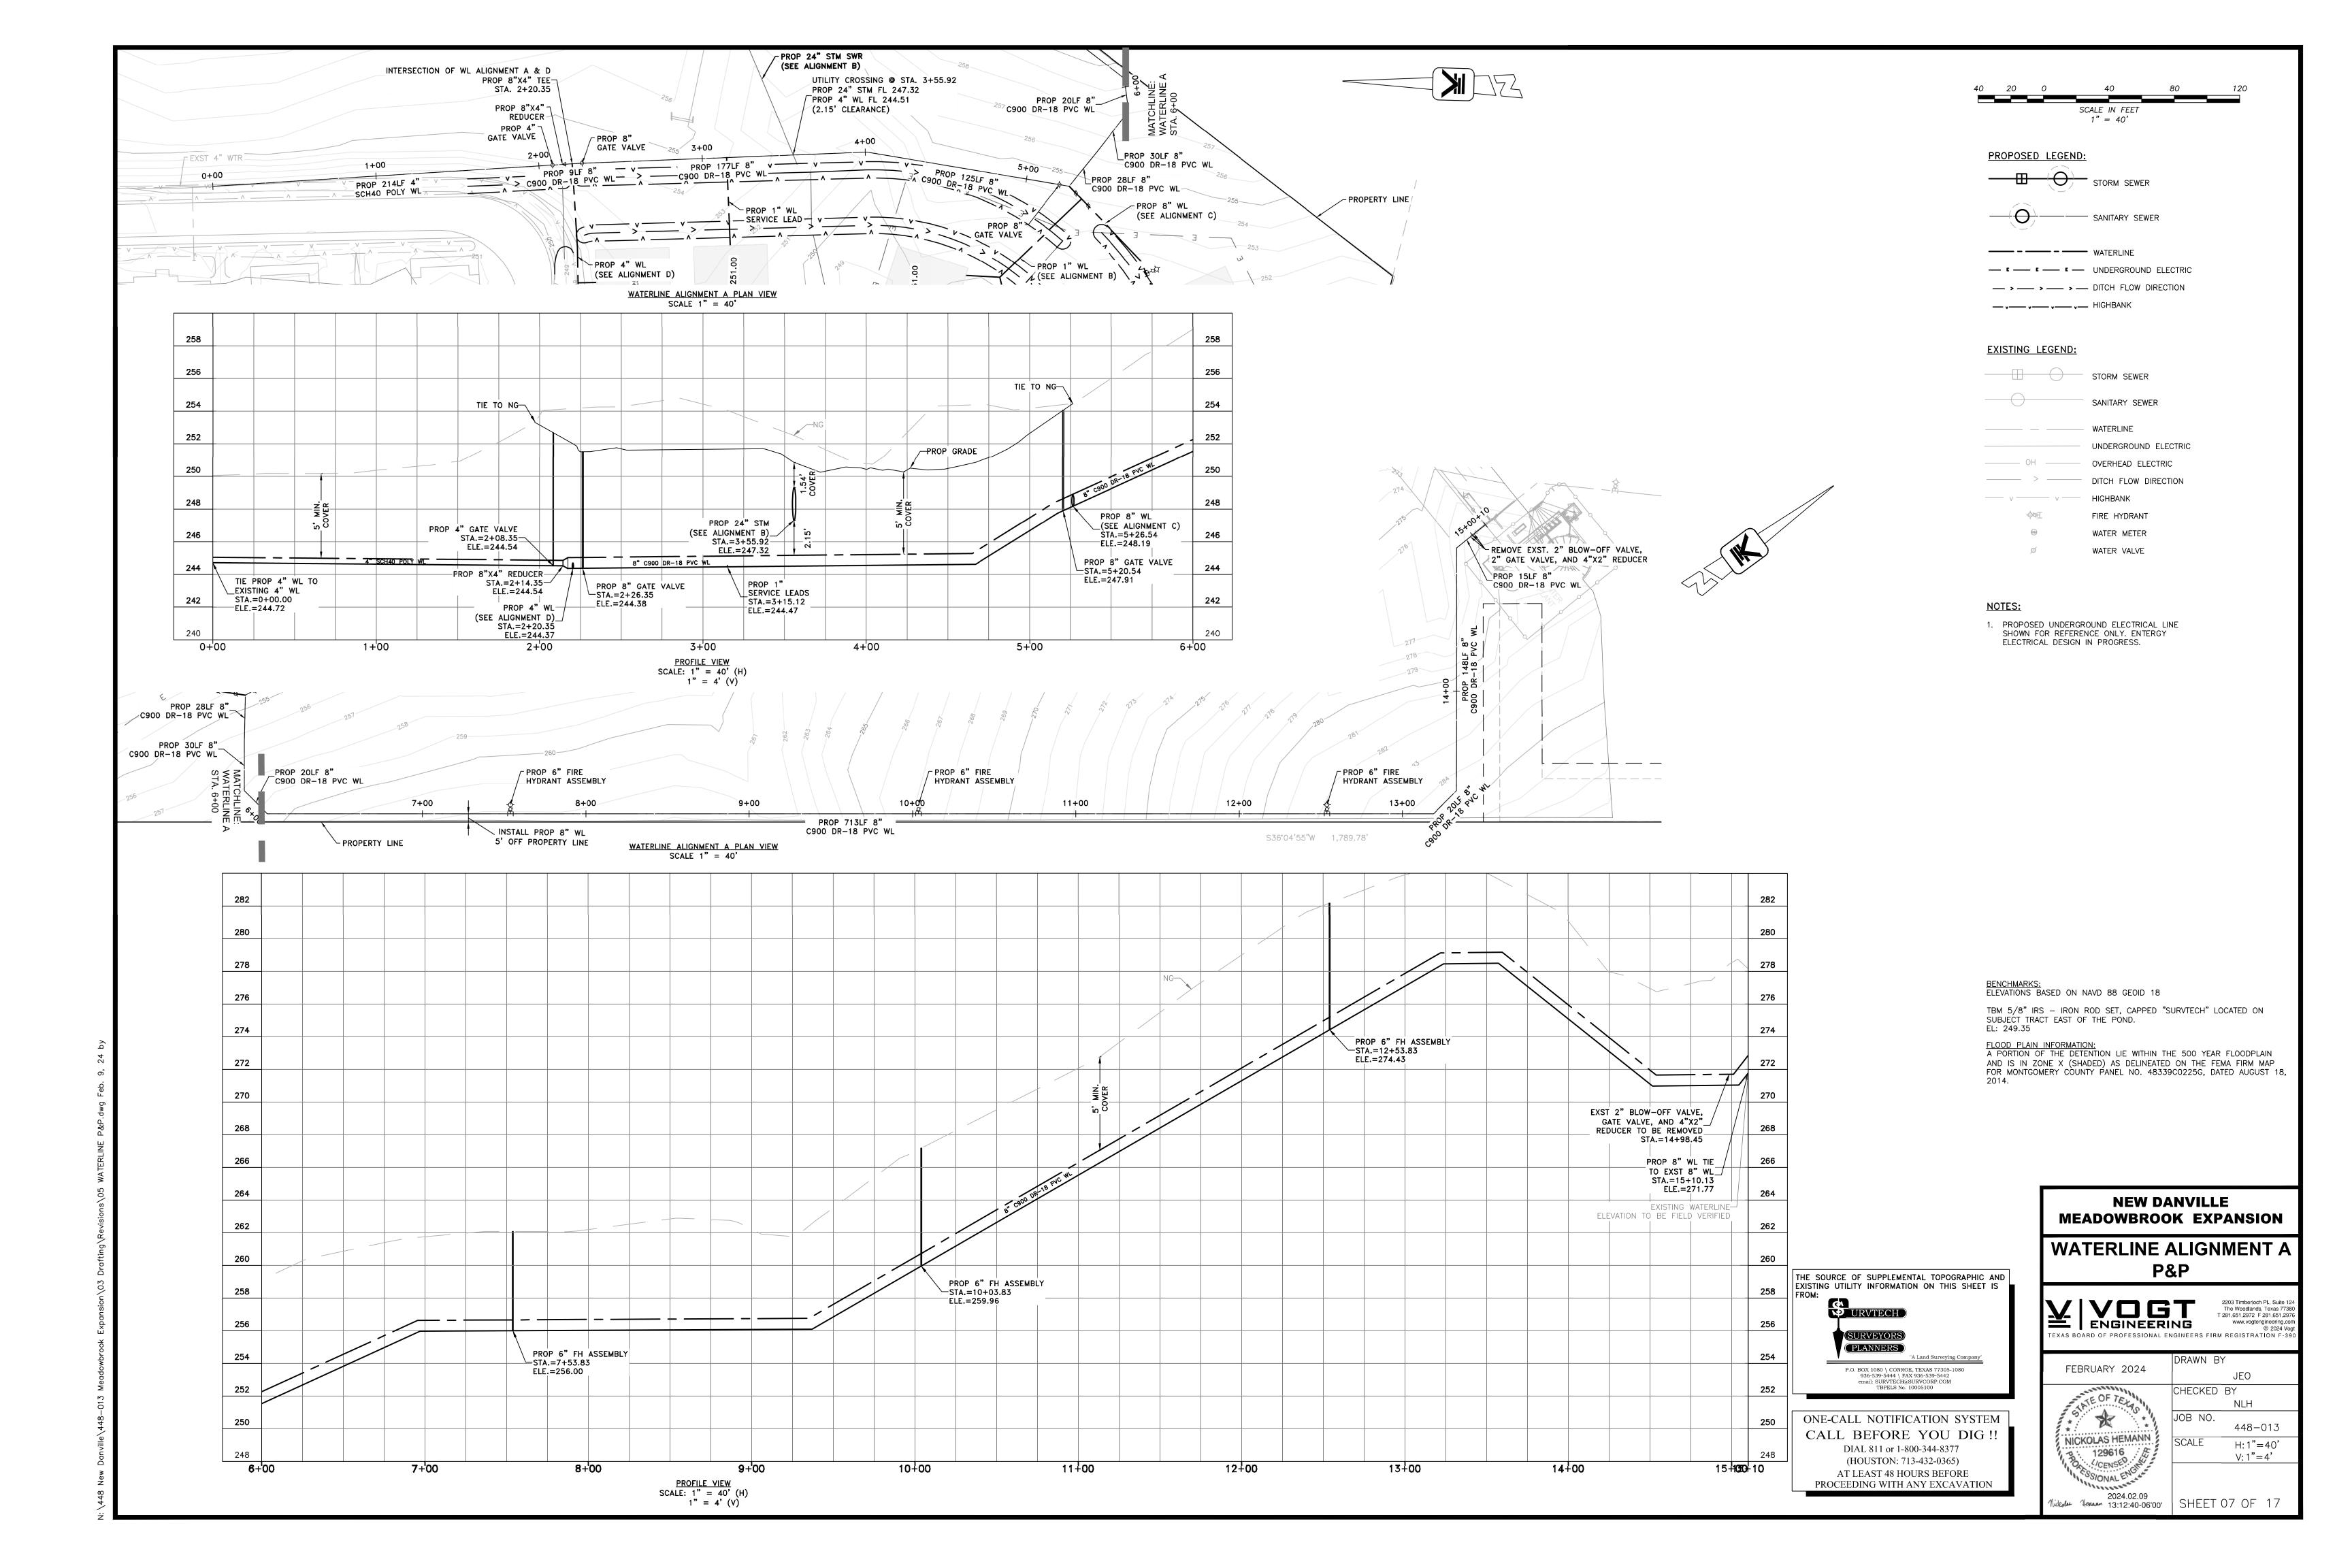

#### PROPOSED LEGEND:

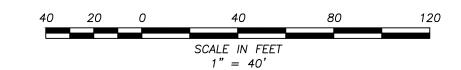

#### EXISTING LEGEND:

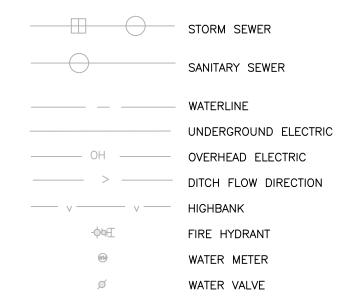

#### NOTES:

 PROPOSED UNDERGROUND ELECTRICAL LINE SHOWN FOR REFERENCE ONLY. ENTERGY ELECTRICAL DESIGN IN PROGRESS.

> BENCHMARKS: ELEVATIONS BASED ON NAVD 88 GEOID 18

TBM 5/8" IRS — IRON ROD SET, CAPPED "SURVTECH" LOCATED ON SUBJECT TRACT EAST OF THE POND. EL: 249.35

FLOOD PLAIN INFORMATION:
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AND IS IN ZONE X (SHADED) AS DELINEATED ON THE FEMA FIRM MAP
FOR MONTGOMERY COUNTY PANEL NO. 48339C0225G, DATED AUGUST 18,
2014.

# THE SOURCE OF SUPPLEMENTAL TOPOGRAPHIC AND EXISTING UTILITY INFORMATION ON THIS SHEET IS FROM: URVTECH SURVEYORS

PLANNERS

"A Land Surveying Comp

P.O. BOX 1080 \ CONROE, TEXAS 77305-1080
936-539-5444 \ FAX 936-539-5442
email: SURVTECH@SURVCORP.COM
TBPELS No. 10005100

ONE-CALL NOTIFICATION SYSTEM
CALL BEFORE YOU DIG!!

DIAL 811 or 1-800-344-8377
(HOUSTON: 713-432-0365)

AT LEAST 48 HOURS BEFORE
PROCEEDING WITH ANY EXCAVATION

# NEW DANVILLE MEADOWBROOK EXPANSION

# WATERLINE ALIGNMENT C P&P



FEBRUARY 2024

NICKOLAS HEMANN

129616

CENSE

JOB NO.

448-013

SCALE

H: 1"=40'


V: 1"=4'

CHECKED BY


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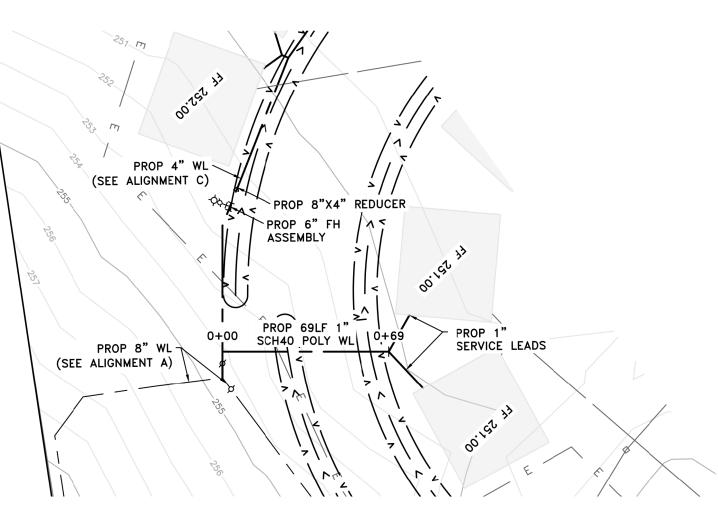
NLH


2024.02.09 Midrolar Henann 13:20:11-06'00' SHEET 08 OF 17

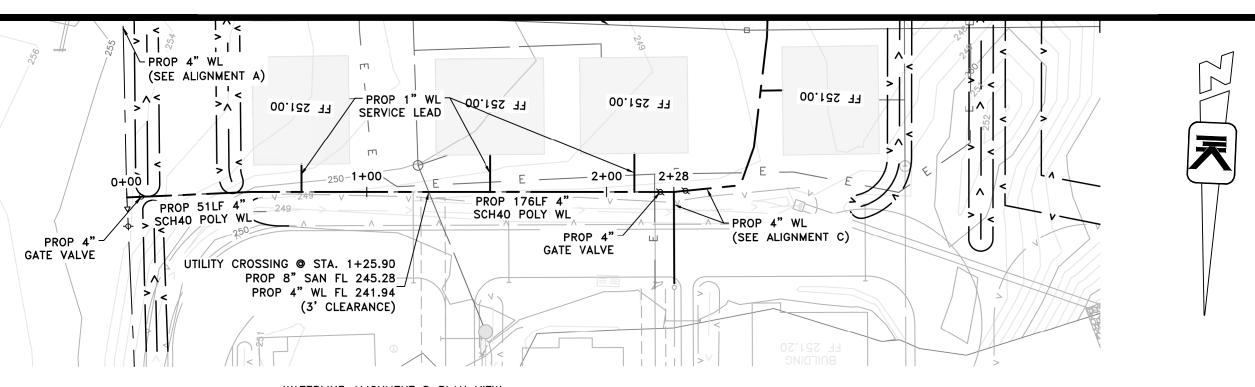


#### WATERLINE ALIGNMENT D PLAN VIEW SCALE 1" = 40'



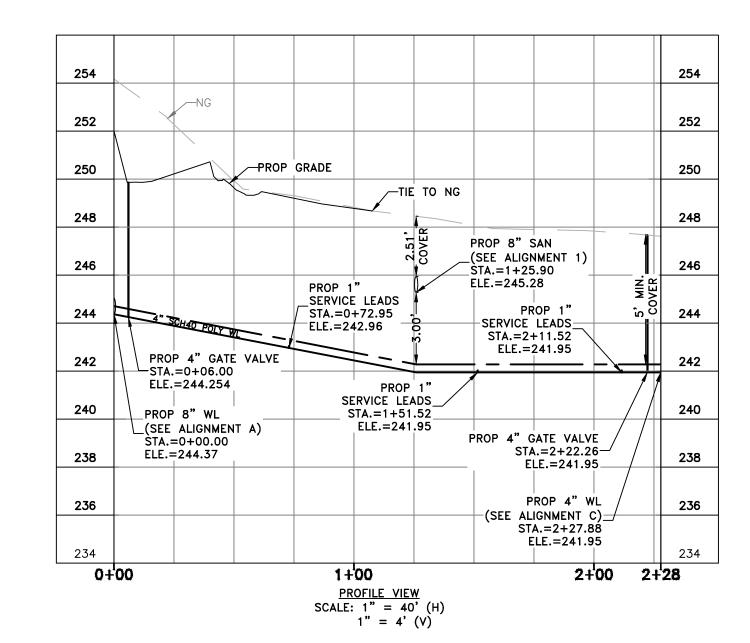


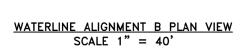

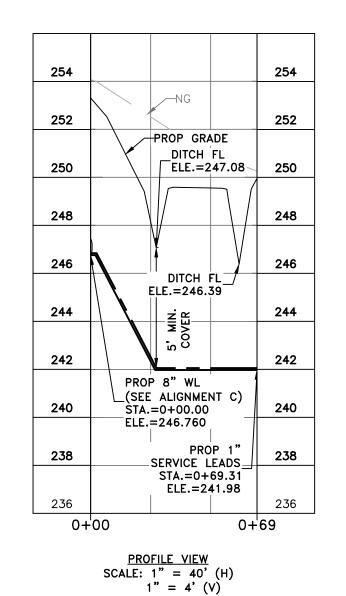




#### PROPOSED LEGEND:

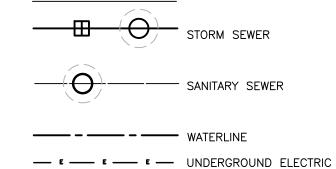

— v— v— v— HIGHBANK

#### **EXISTING LEGEND:**

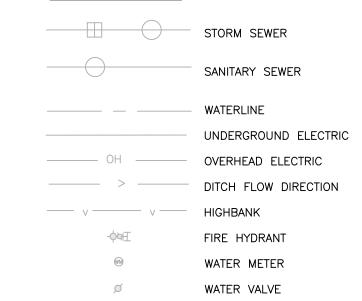

PROPOSED UNDERGROUND ELECTRICAL LINE SHOWN FOR REFERENCE ONLY. ENTERGY ELECTRICAL DESIGN IN PROGRESS.


BENCHMARKS: ELEVATIONS BASED ON NAVD 88 GEOID 18

TBM 5/8" IRS - IRON ROD SET, CAPPED "SURVTECH" LOCATED ON SUBJECT TRACT EAST OF THE POND. EL: 249.35

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> **NEW DANVILLE MEADOWBROOK EXPANSION**

> WATERLINE ALIGNMENT B & D P&P

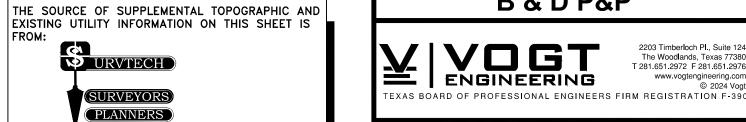

P.O. BOX 1080 \ CONROE, TEXAS 77305-1080 936-539-5444 \ FAX 936-539-5442 email: SURVTECH@SURVCORP.COM TBPELS No. 10005100

ONE-CALL NOTIFICATION SYSTEM CALL BEFORE YOU DIG!! DIAL 811 or 1-800-344-8377 (HOUSTON: 713-432-0365) AT LEAST 48 HOURS BEFORE PROCEEDING WITH ANY EXCAVATION

FEBRUARY 2024 STATE OF TELO NICKOLAS HEMANN 129616

2024.02.09 Nideolar Henam 13:20:31-06:00' SHEET 09 OF 17

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DRAWN BY

CHECKED BY

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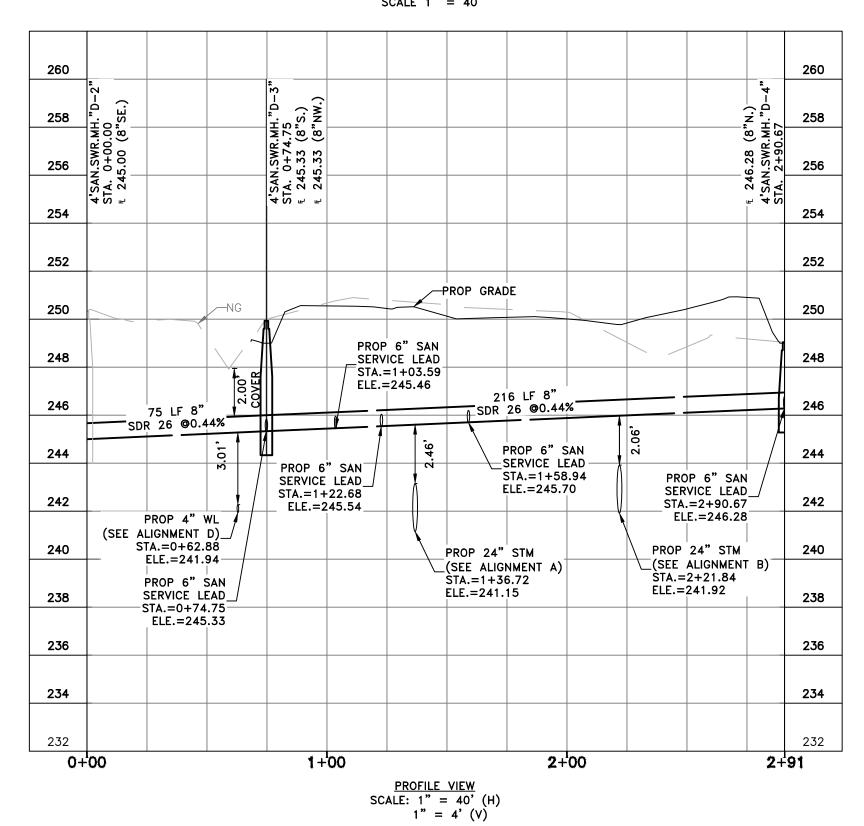
NLH


448-013

H: 1"=40'


V: 1"=4'

## SCALE 1" = 40'



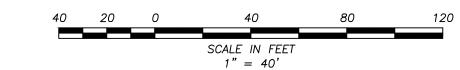


#### PROPOSED LEGEND:

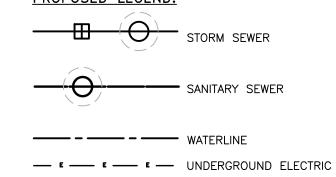

— v— v— v— HIGHBANK

**EXISTING LEGEND:** 

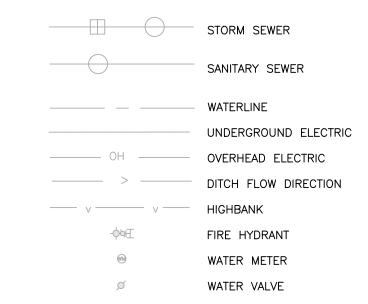

PROPOSED UNDERGROUND ELECTRICAL LINE SHOWN FOR REFERENCE ONLY. ENTERGY ELECTRICAL DESIGN IN PROGRESS.

<u>BENCHMARKS:</u> ELEVATIONS BASED ON NAVD 88 GEOID 18

TBM 5/8" IRS - IRON ROD SET, CAPPED "SURVTECH" LOCATED ON SUBJECT TRACT EAST OF THE POND. EL: 249.35

FLOOD PLAIN INFORMATION:
A PORTION OF THE DETENTION LIE WITHIN THE 500 YEAR FLOODPLAIN AND IS IN ZONE X (SHADED) AS DELINEATED ON THE FEMA FIRM MAP FOR MONTGOMERY COUNTY PANEL NO. 48339C0225G, DATED AUGUST 18,

THE SOURCE OF SUPPLEMENTAL TOPOGRAPHIC AND EXISTING UTILITY INFORMATION ON THIS SHEET IS URVTECH PLANNERS

P.O. BOX 1080 \ CONROE, TEXAS 77305-1080 936-539-5444 \ FAX 936-539-5442 email: SURVTECH@SURVCORP.COM TBPELS No. 10005100

ONE-CALL NOTIFICATION SYSTEM CALL BEFORE YOU DIG!! DIAL 811 or 1-800-344-8377 (HOUSTON: 713-432-0365) AT LEAST 48 HOURS BEFORE PROCEEDING WITH ANY EXCAVATION

**NEW DANVILLE MEADOWBROOK EXPANSION** 

**SANITARY ALIGNMENT 1** P&P



2203 Timberloch Pl., Suite 124 The Woodlands, Texas 77380 T 281.651.2972 F 281.651.2976 ENGINEERING

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TEXAS BOARD OF PROFESSIONAL ENGINEERS FIRM REGISTRATION F-390 DRAWN BY

FEBRUARY 2024 STATE OF TELY NICKOLAS HEMANN 129616

2024.02.09


JOB NO. 448-013 H: 1" = 40'V: 1"=4'

CHECKED BY


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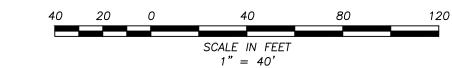
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NLH




#### SANITARY ALIGNMENT 2 PLAN VIEW

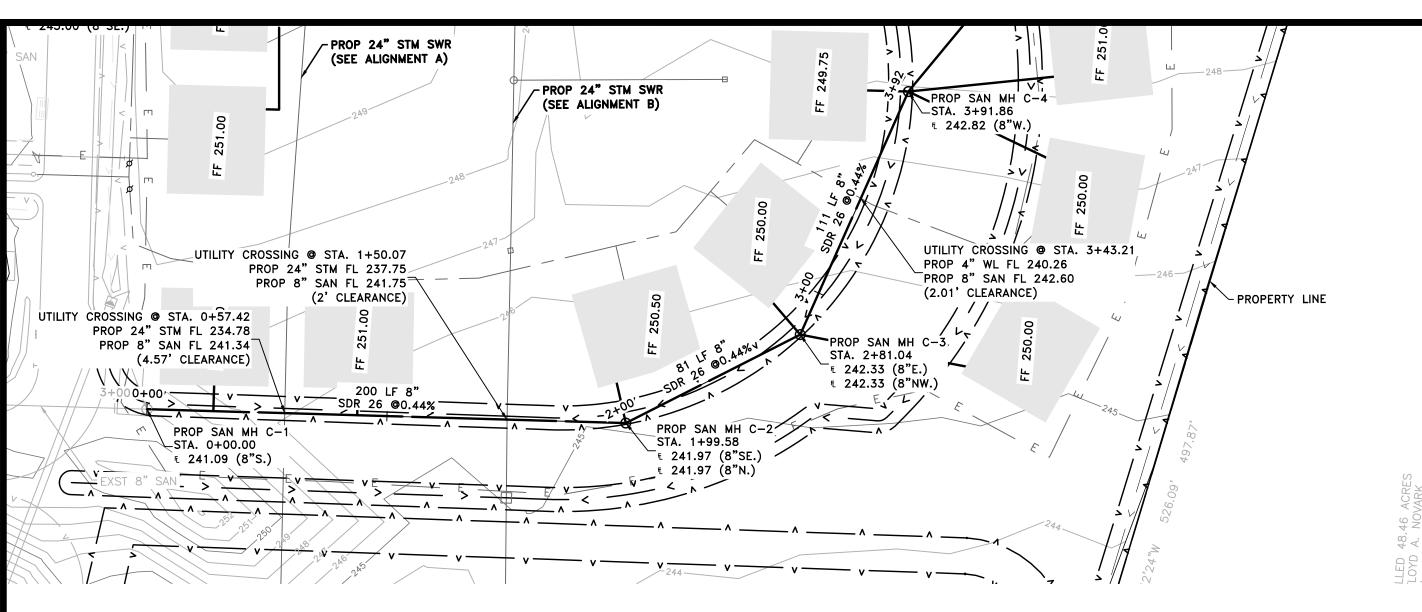


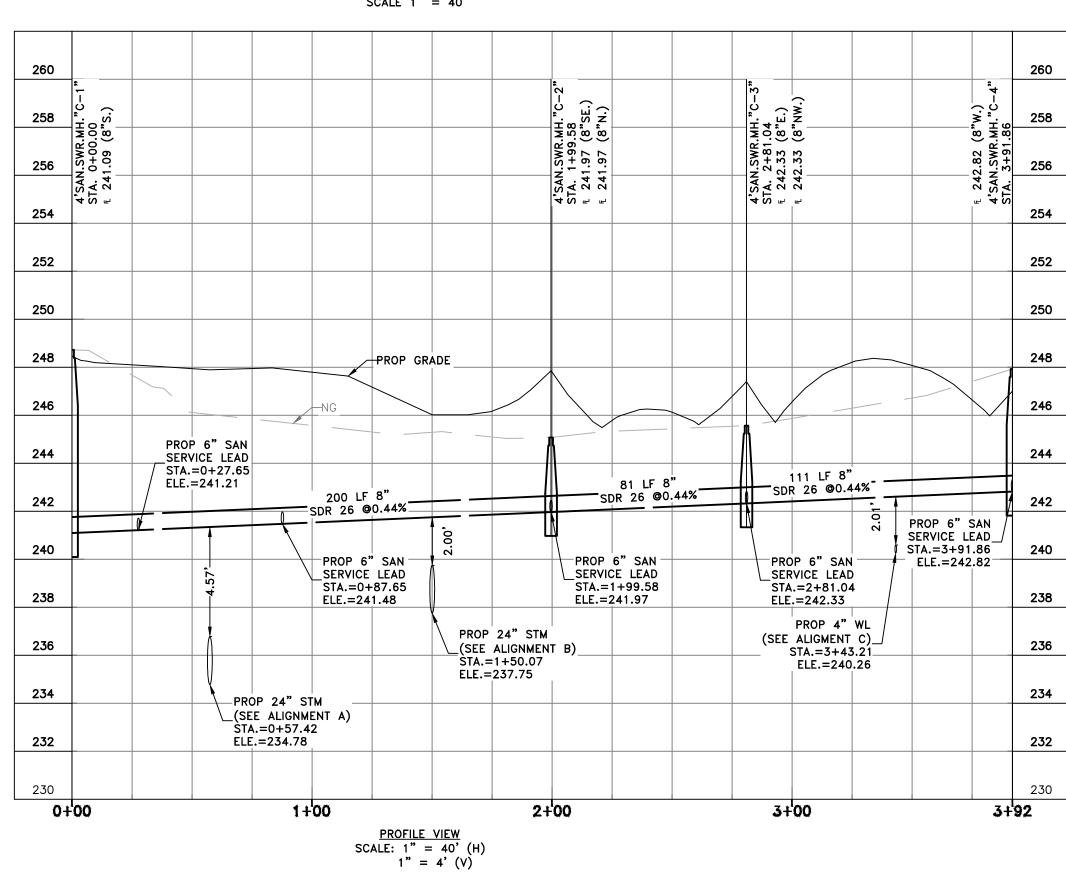

#### PROPOSED LEGEND:

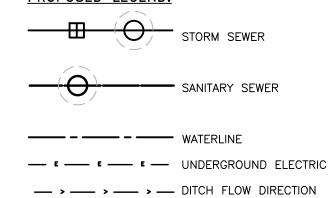

#### **EXISTING LEGEND:**

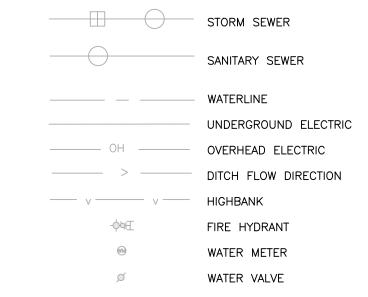

PROPOSED UNDERGROUND ELECTRICAL LINE SHOWN FOR REFERENCE ONLY. ENTERGY ELECTRICAL DESIGN IN PROGRESS.

BENCHMARKS: ELEVATIONS BASED ON NAVD 88 GEOID 18

TBM 5/8" IRS - IRON ROD SET, CAPPED "SURVTECH" LOCATED ON SUBJECT TRACT EAST OF THE POND. EL: 249.35

FLOOD PLAIN INFORMATION:
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THE SOURCE OF SUPPLEMENTAL TOPOGRAPHIC AND EXISTING UTILITY INFORMATION ON THIS SHEET IS URVTECH PLANNERS

P.O. BOX 1080 \ CONROE, TEXAS 77305-1080 936-539-5444 \ FAX 936-539-5442 email: SURVTECH@SURVCORP.COM TBPELS No. 10005100

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**NEW DANVILLE MEADOWBROOK EXPANSION** 

**SANITARY ALIGNMENT 2** P&P



DRAWN BY FEBRUARY 2024 CHECKED BY STATE OF TELY JOB NO. NICKOLAS HEMANN 1250 CENSED

2024.02.09 Nideolar Henarm 13:21:26-06'00' SHEET 11 OF 17


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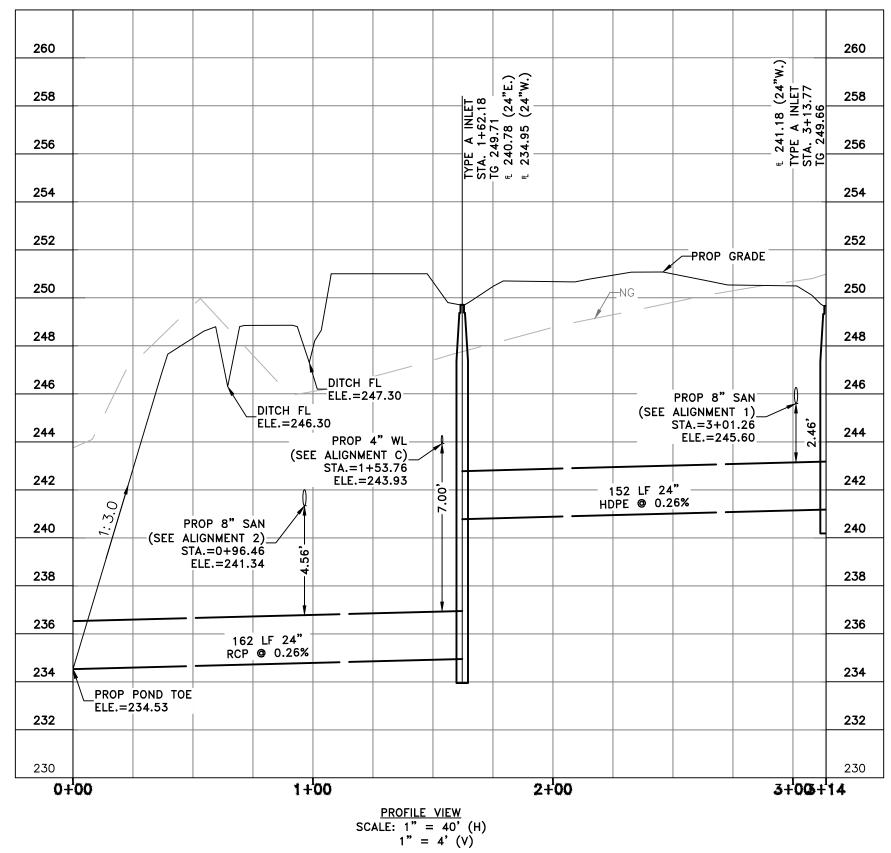
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448-013

H: 1"=40'


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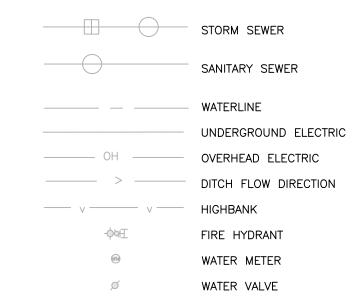
SCALE IN FEET 1" = 40'

#### PROPOSED LEGEND:

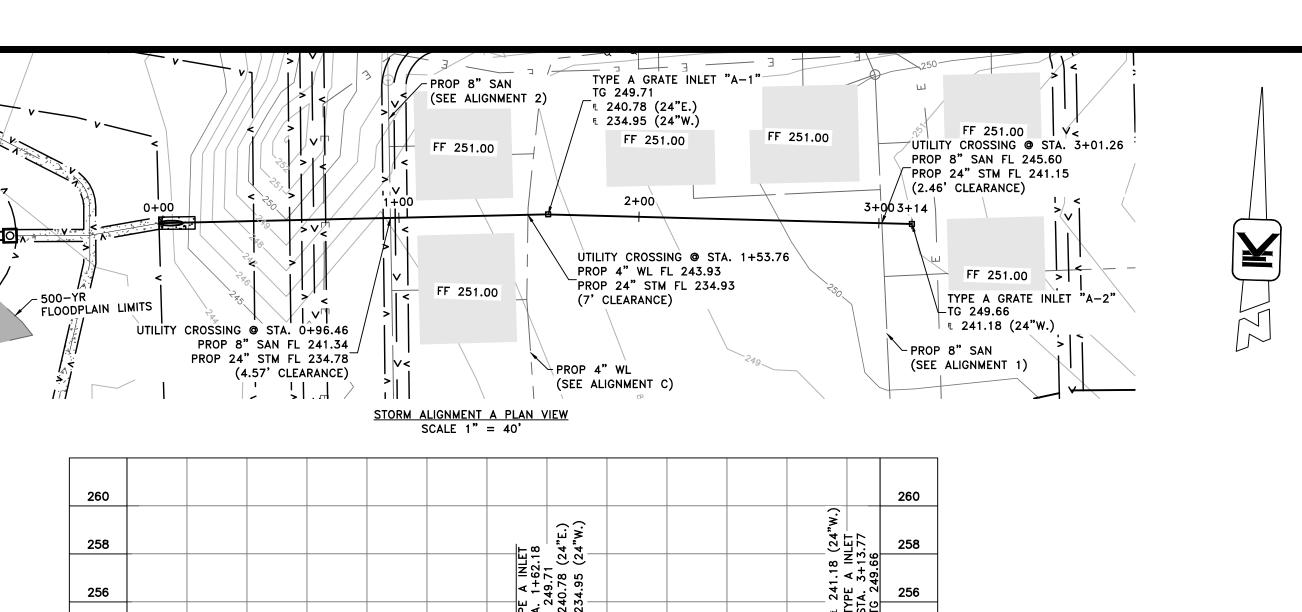

— v— v— v— HIGHBANK

#### **EXISTING LEGEND:**

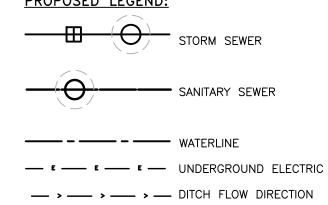

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> PLANNERS P.O. BOX 1080 \ CONROE, TEXAS 77305-1080 936-539-5444 \ FAX 936-539-5442 email: SURVTECH@SURVCORP.COM TBPELS No. 10005100

ONE-CALL NOTIFICATION SYSTEM CALL BEFORE YOU DIG!! DIAL 811 or 1-800-344-8377 (HOUSTON: 713-432-0365) AT LEAST 48 HOURS BEFORE PROCEEDING WITH ANY EXCAVATION

**NEW DANVILLE MEADOWBROOK EXPANSION** 

STORM ALIGNMENT A P&P



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CHECKED BY

FEBRUARY 2024 STATE OF TELY NICKOLAS HEMANN 129616

2024.02.09

JOB NO. H: 1" = 40'


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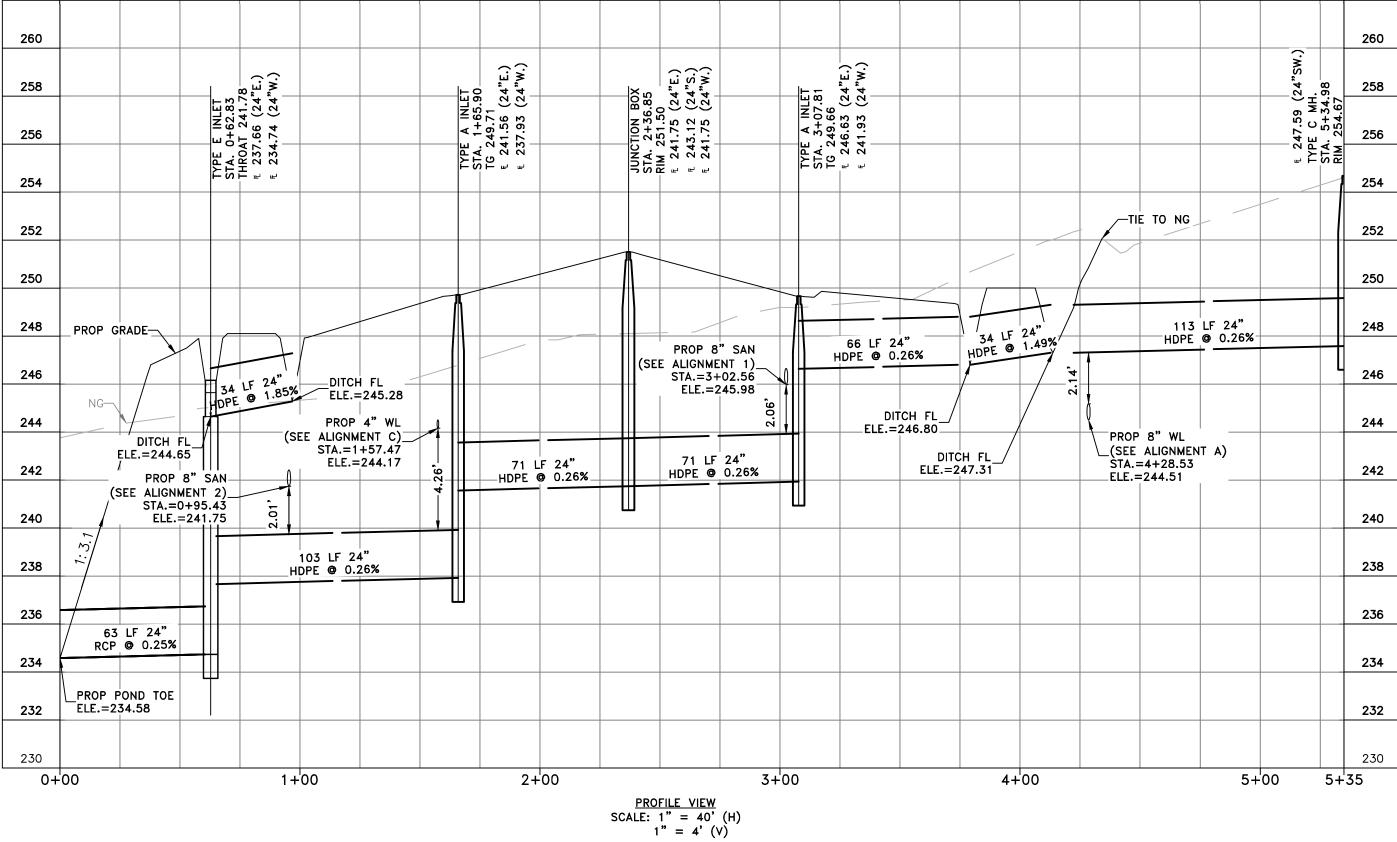
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NLH

448-013

V: 1"=4'






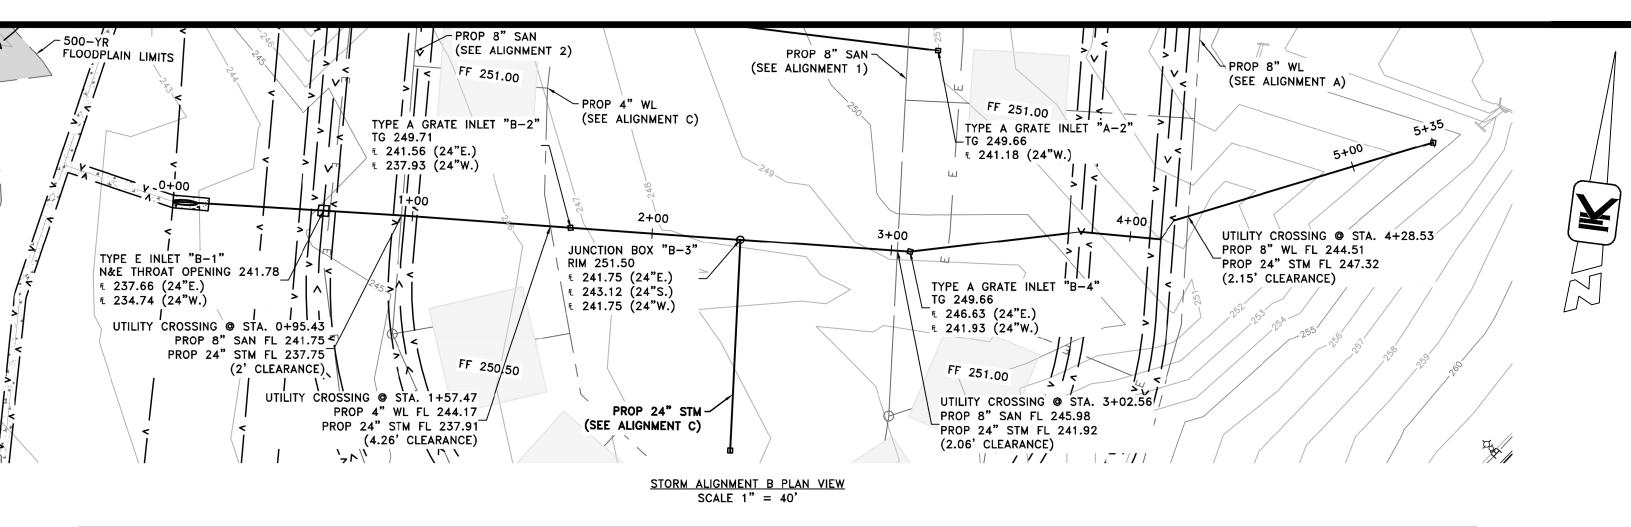


1" = 40'

#### PROPOSED LEGEND:

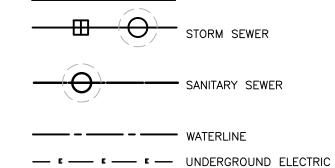



— "— "— "— HIGHBANK

#### **EXISTING LEGEND:**

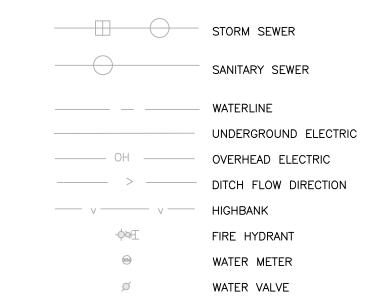

PROPOSED UNDERGROUND ELECTRICAL LINE SHOWN FOR REFERENCE ONLY. ENTERGY ELECTRICAL DESIGN IN PROGRESS.

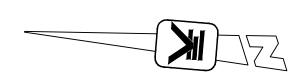

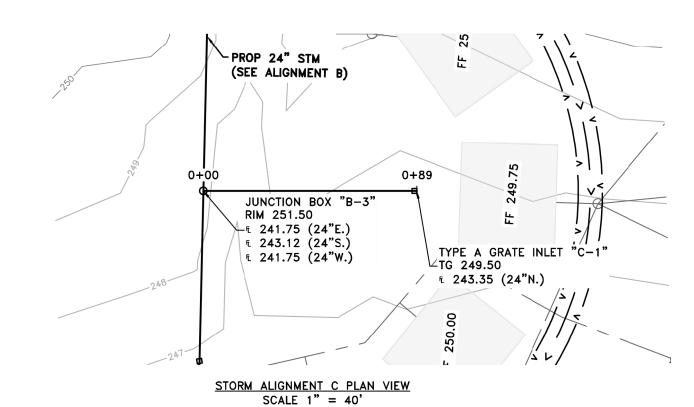

	1	ì		1 1	
260					260
258	BOX .00 (24"E.)	(24"S.) (24"W.)	(24"N.)	.94	258
256	JUNCTION BOX STA. 0+00.00 RIM 251.50 F 241.75 (24"E.)	243.12	243.35	TYPE A INLE! STA. 0+88.94 TG 249.50	256
254	STE I	یں بی	<u>ب</u> (		254
252					252
250		PROP	GRADE		250
248			-NG		248
246					246
244		89 LF :	24"		244
242	1	HDPE @ -	0.26%		242
240					240
238					238
236					236

PROFILE VIEW
SCALE: 1" = 40' (H)

BENCHMARKS: ELEVATIONS BASED ON NAVD 88 GEOID 18

TBM 5/8" IRS - IRON ROD SET, CAPPED "SURVTECH" LOCATED ON SUBJECT TRACT EAST OF THE POND. EL: 249.35

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#### **NEW DANVILLE MEADOWBROOK EXPANSION**

#### STORM ALIGNMENT B & C P&P



FEBRUARY 2024 STATE OF TELAS NICKOLAS HEMANN 129616

CHECKED BY JOB NO.

448-013 H: 1" = 40'V: 1" = 4'

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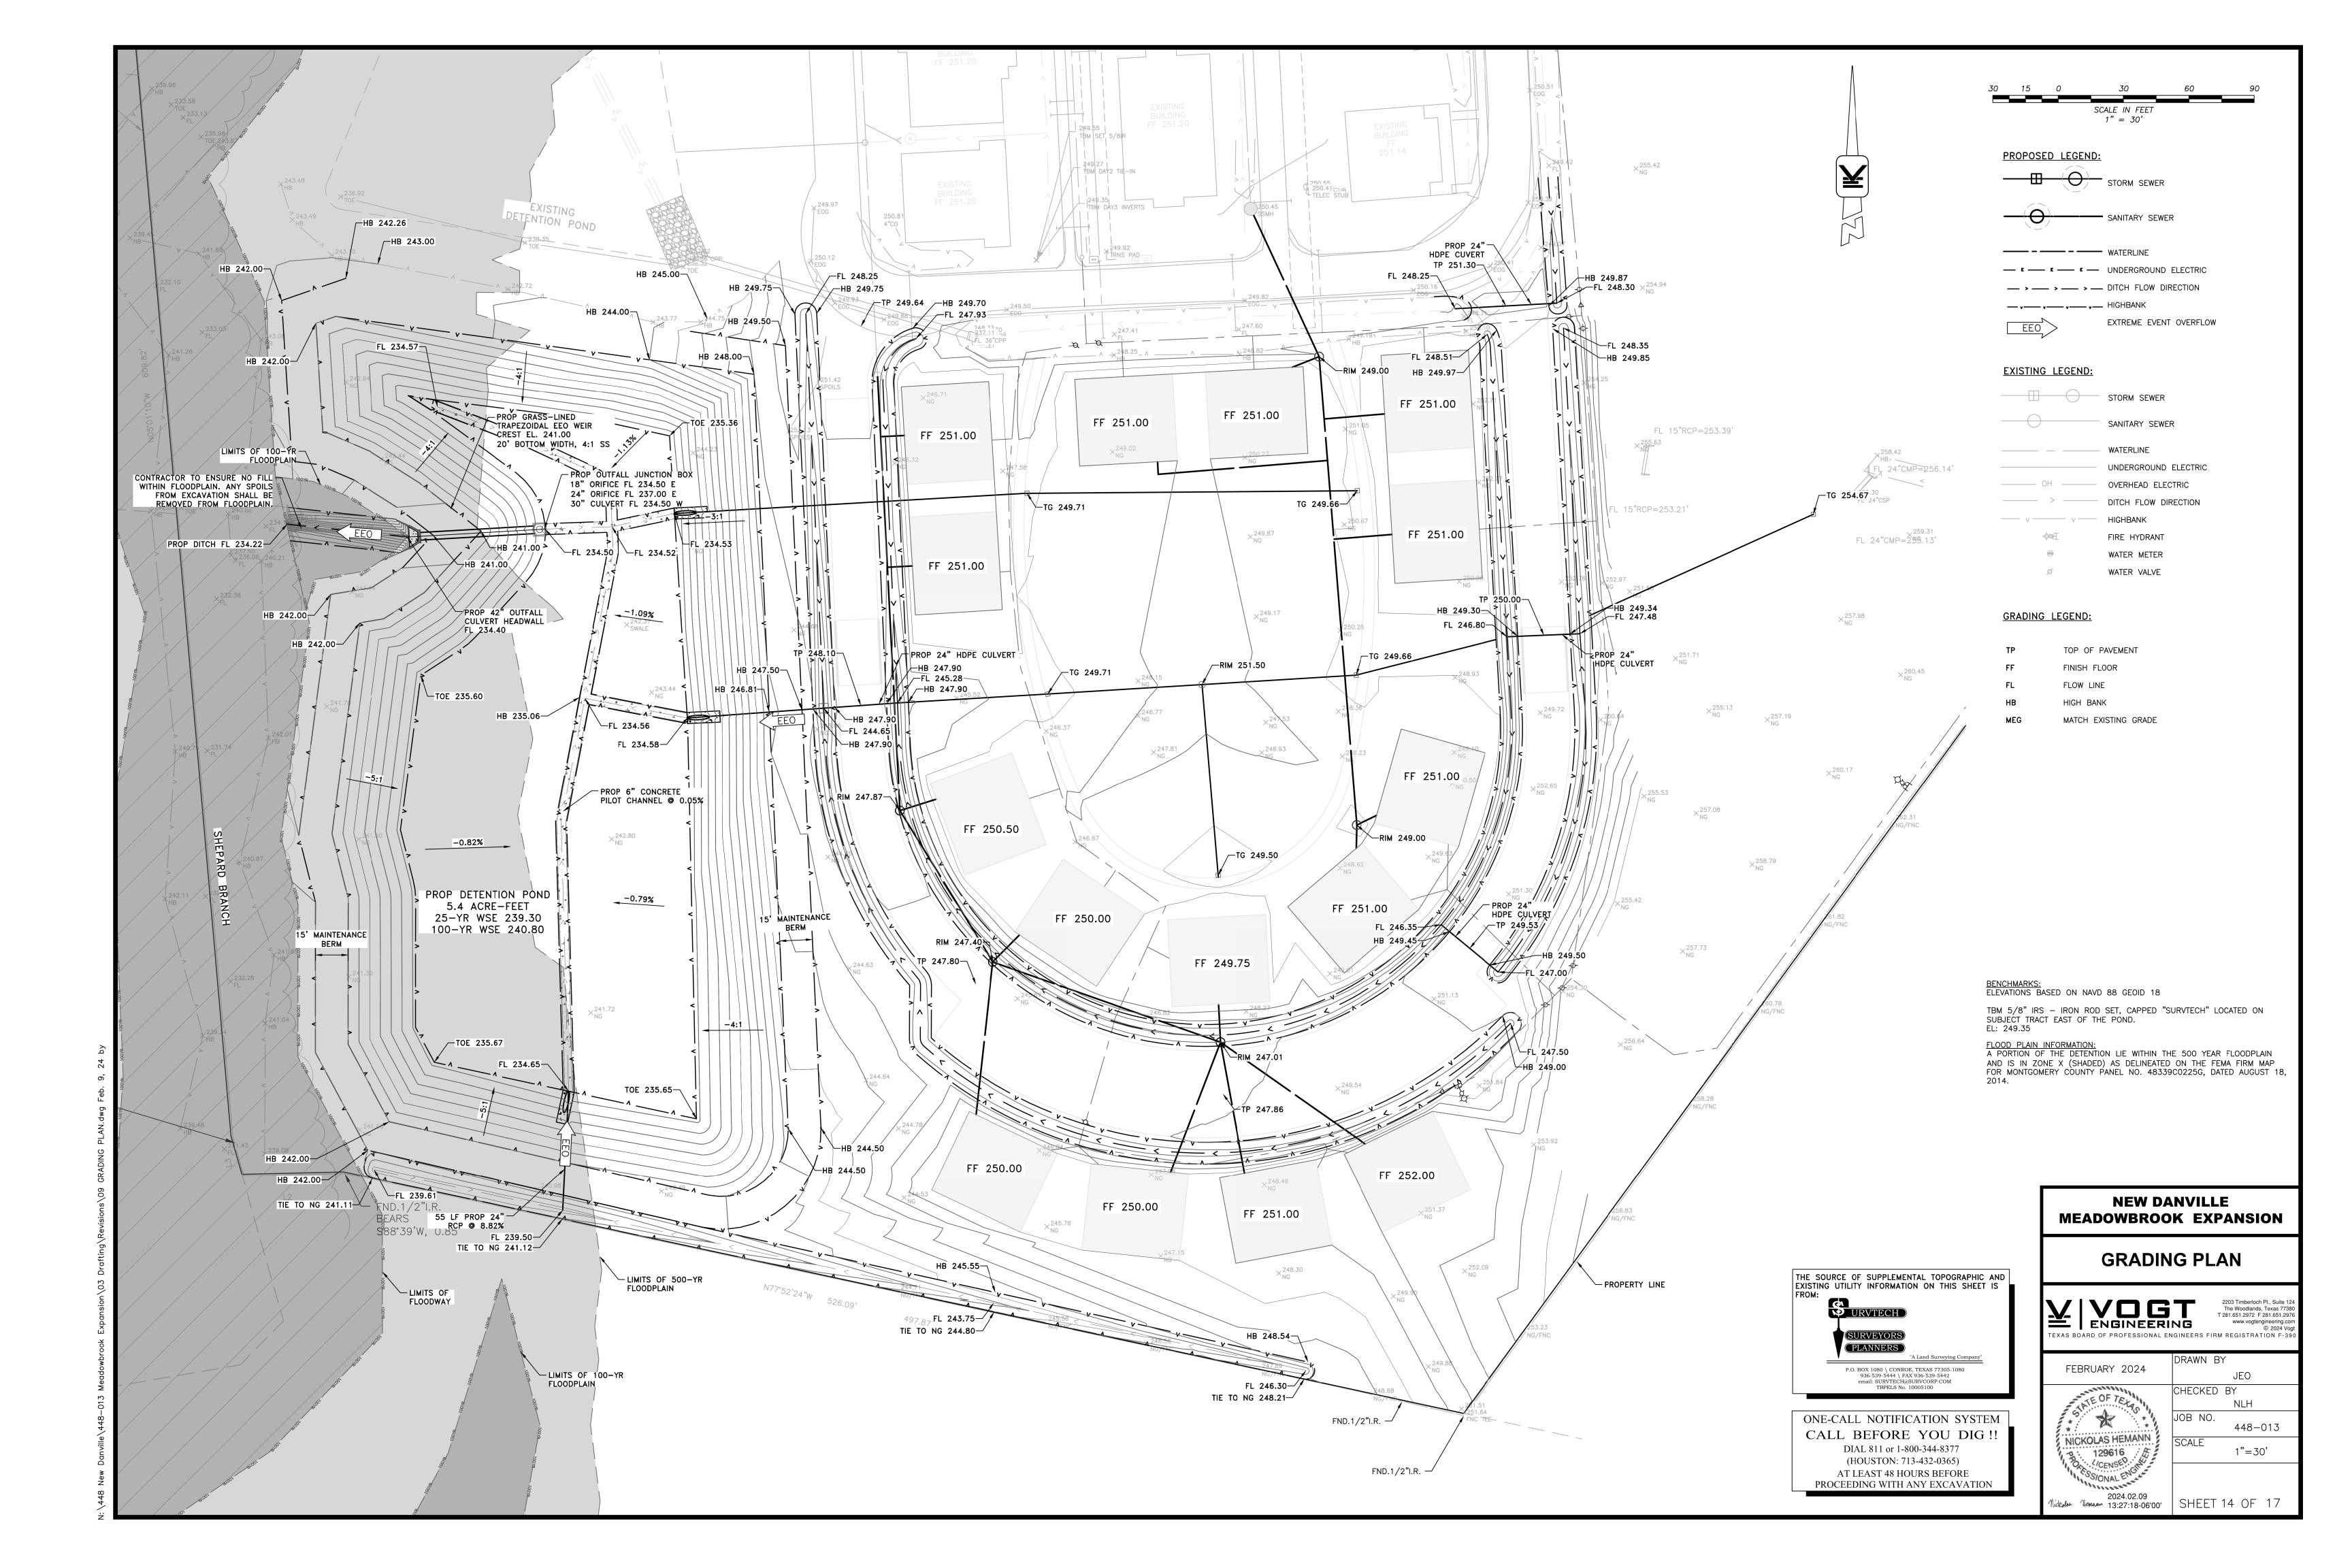
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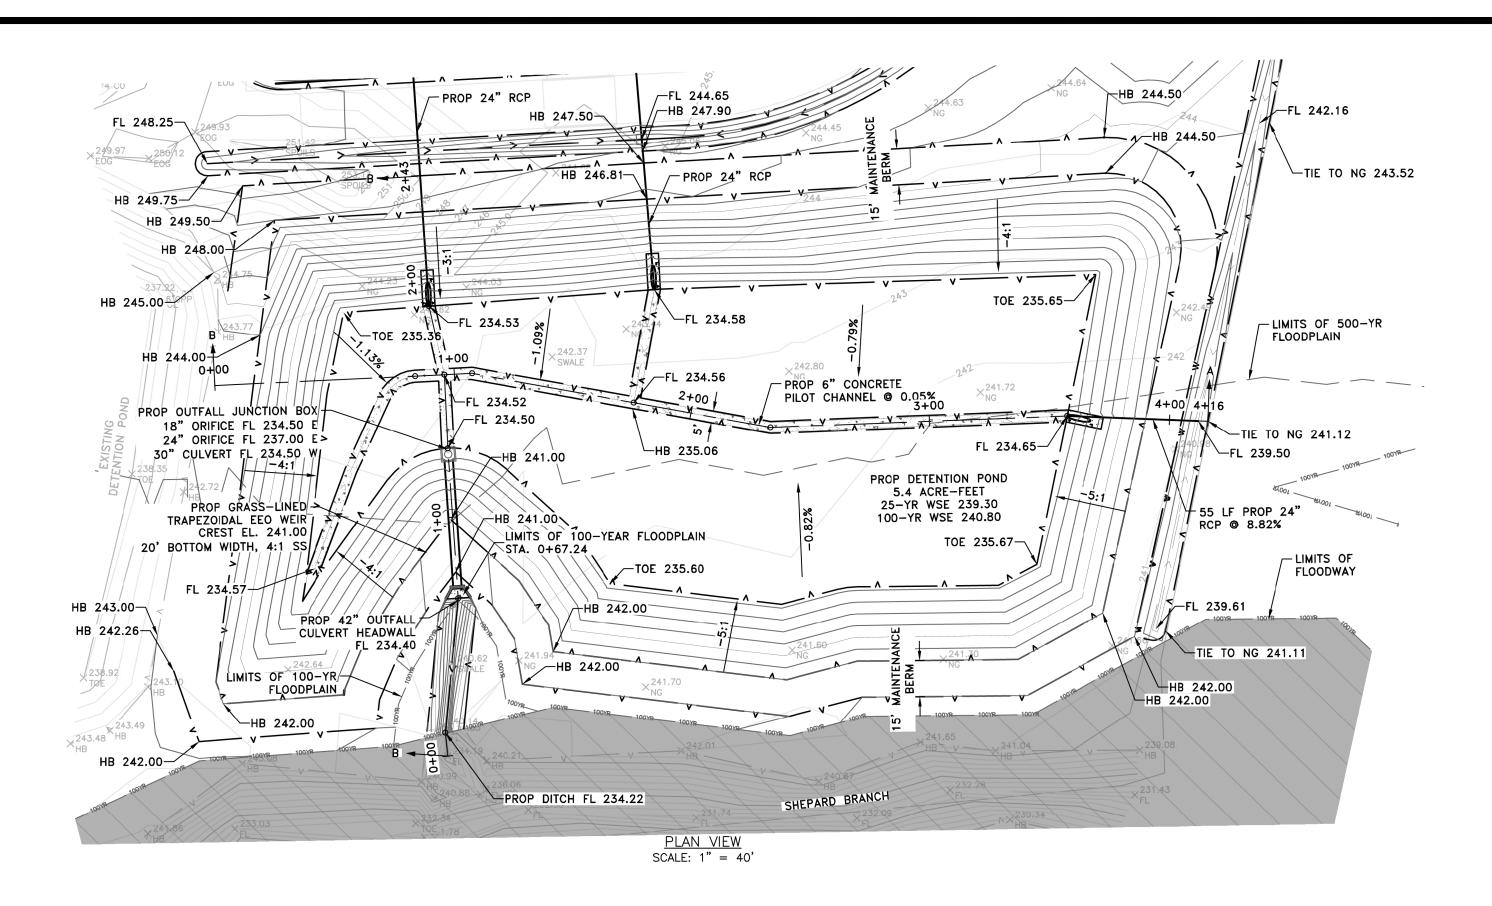
> P.O. BOX 1080 \ CONROE, TEXAS 77305-1080 936-539-5444 \ FAX 936-539-5442 email: SURVTECH@SURVCORP.COM TBPELS No. 10005100


ONE-CALL NOTIFICATION SYSTEM CALL BEFORE YOU DIG!! DIAL 811 or 1-800-344-8377 (HOUSTON: 713-432-0365) AT LEAST 48 HOURS BEFORE PROCEEDING WITH ANY EXCAVATION


PLANNERS


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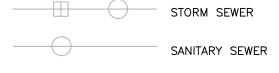
#### PROPOSED LEGEND:

- SANITARY SEWER

\_\_\_\_\_\_ HIGHBANK

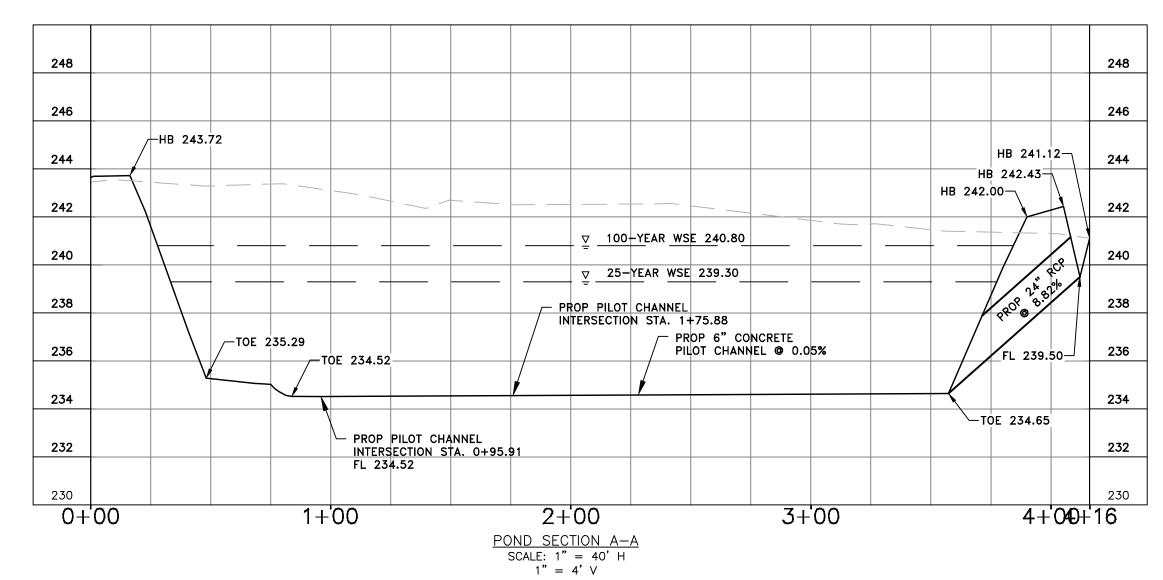----- WATERLINE — E — E — UNDERGROUND ELECTRIC 
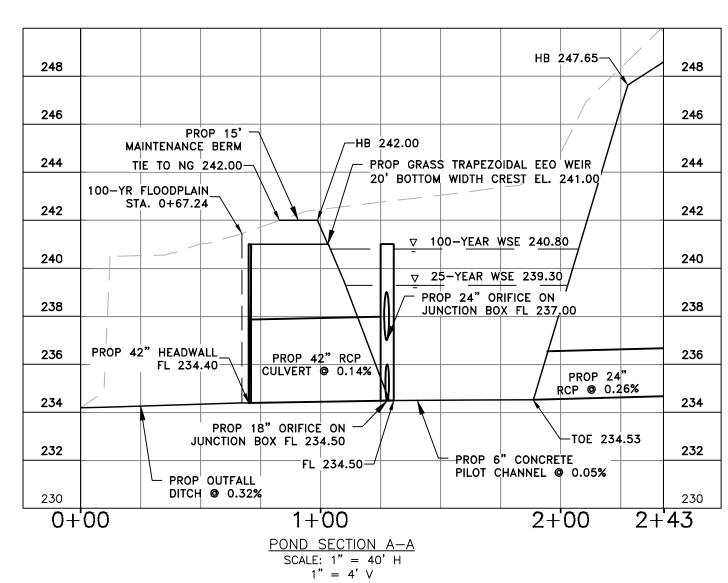
#### **EXISTING LEGEND:**

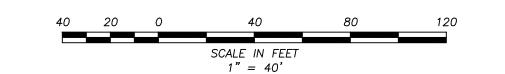

WATERLINE UNDERGROUND ELECTRIC OH OVERHEAD ELECTRIC

DITCH FLOW DIRECTION

---- v ----- HIGHBANK FIRE HYDRANT

WATER METER WATER VALVE

BENCHMARKS: ELEVATIONS BASED ON NAVD 88 GEOID 18

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#### **NEW DANVILLE MEADOWBROOK EXPANSION**

#### **DETENTION POND P&P**

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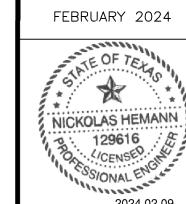
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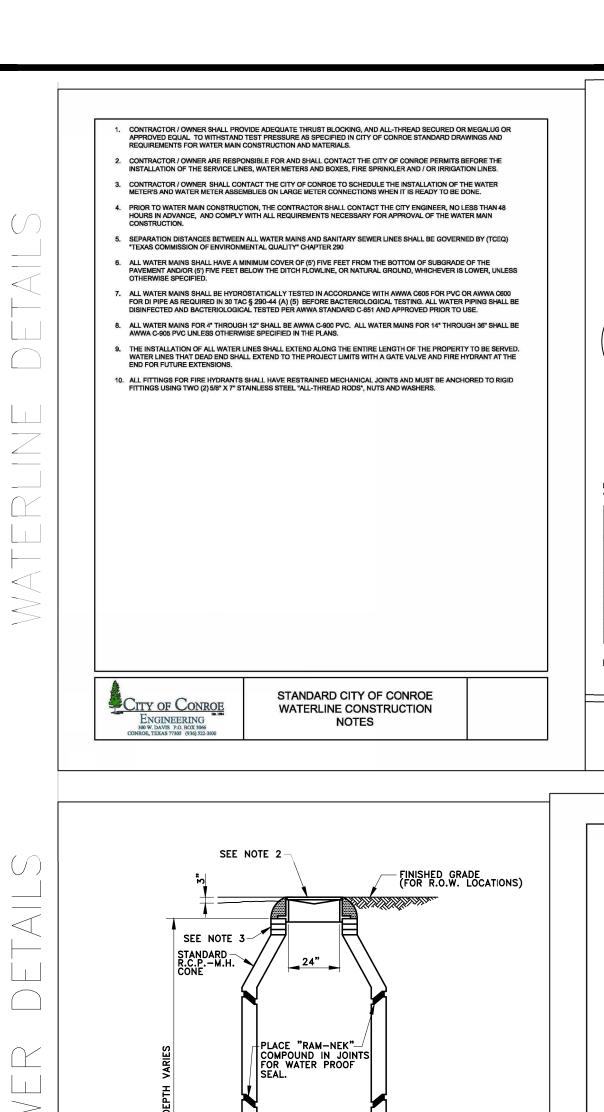
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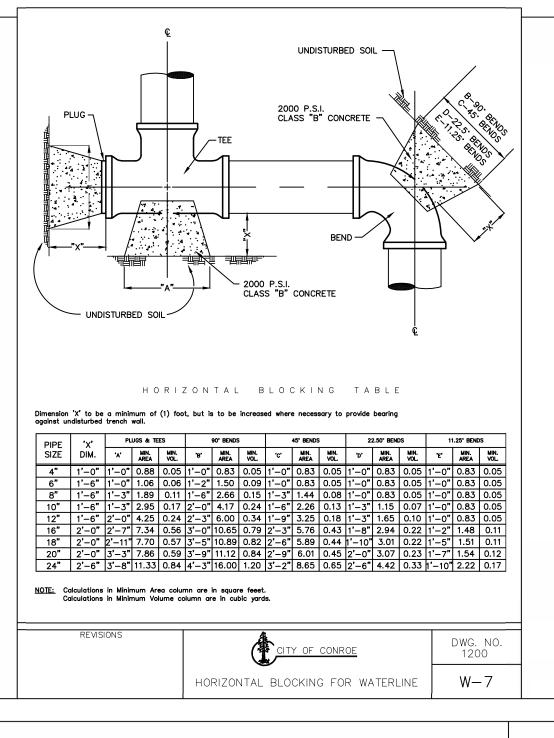
2203 Timberloch Pl., Suite 124 The Woodlands, Texas 77386 T 281 651 2972 F 281 651 2976


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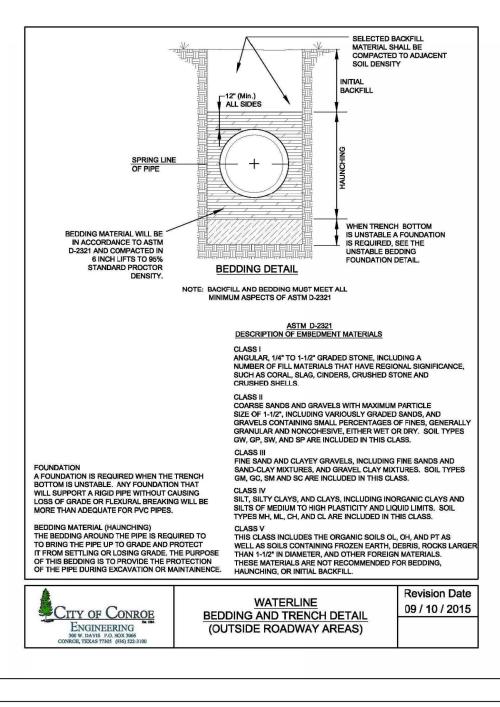
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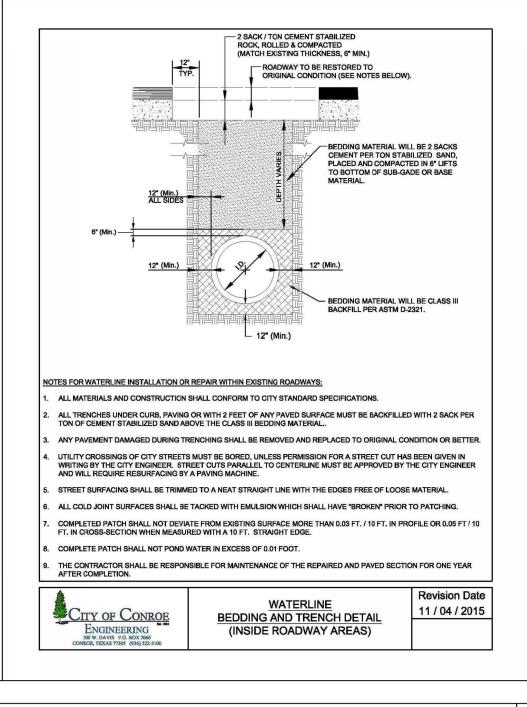
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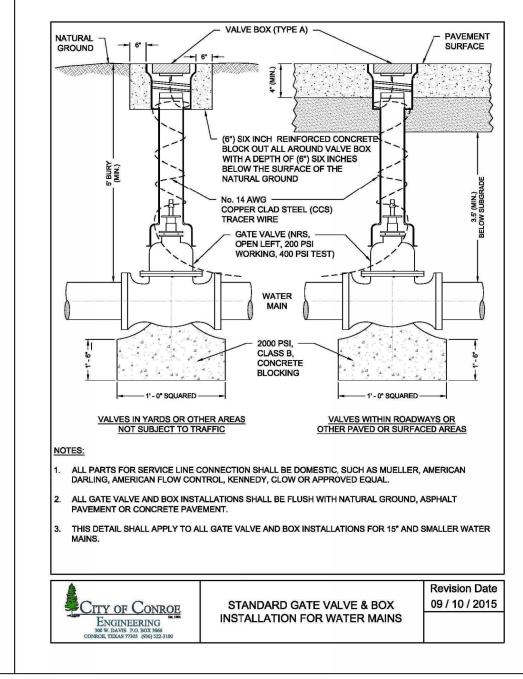













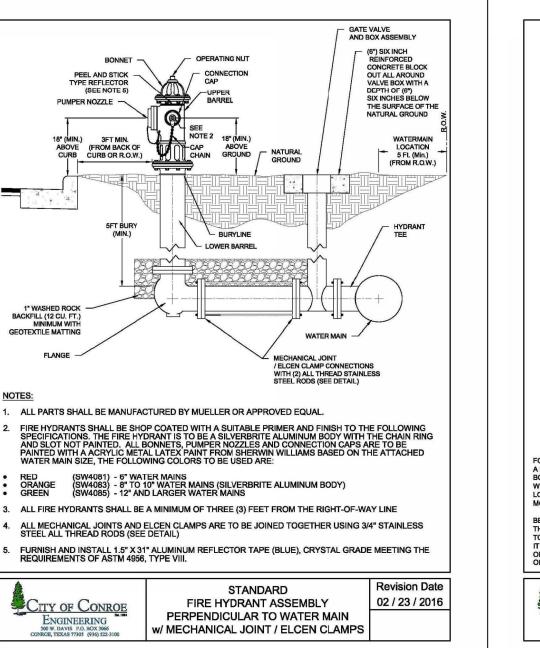

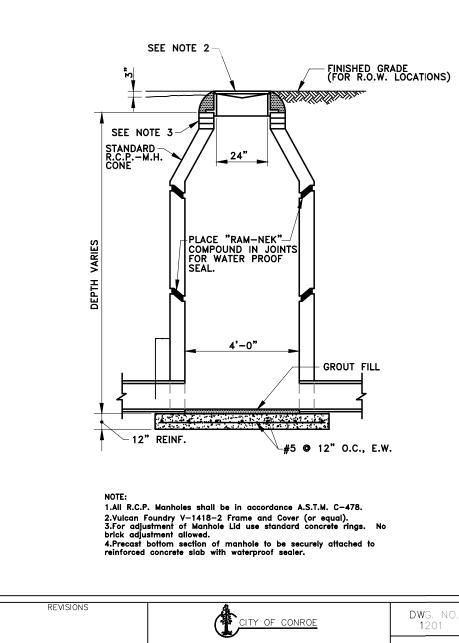


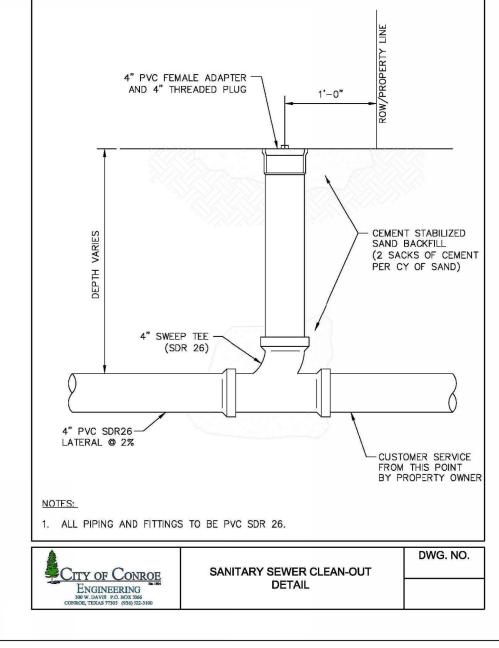


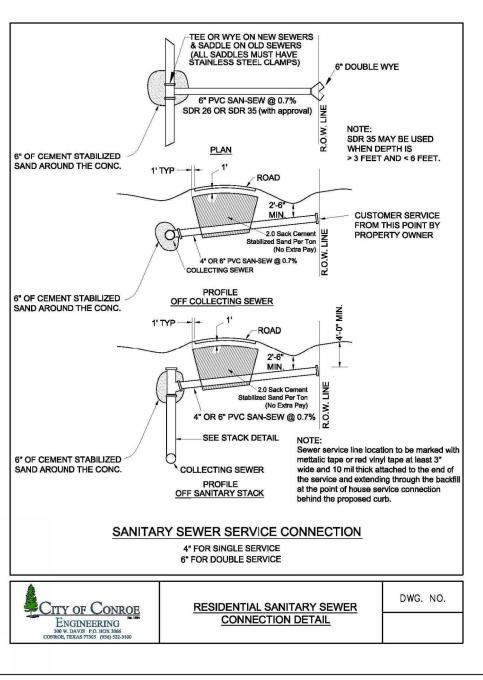



CONSTRUCTION AND TESTING OF SANITARY SEWER SHALL BE IN ACCORDANCE WITH THE LATEST CITY OF CONROE AND TCEQ SPECIFICATIONS. THE MOST STRINGENT SHALL GOVERN.

BACKFILL AND BEDDING FOR SANITARY SEWERS MUST MEET ALL MINIMUM REQUIREMENTS OF ASTM D-2321 AND MUST BE IN ACCORDANCE WITH CITY OF CONROE EXCAVATION, BEDDING AND BACKFILL PROCEDURES.

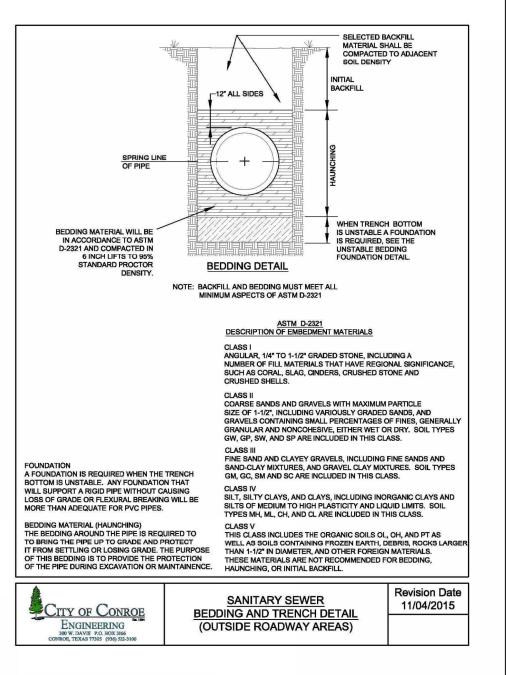

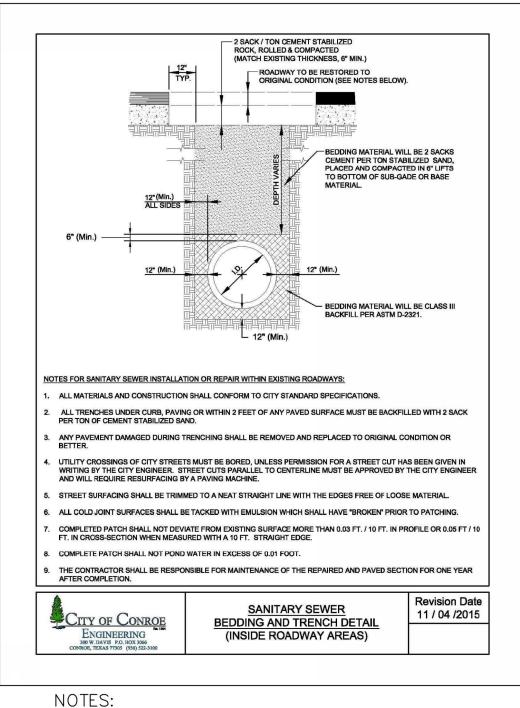

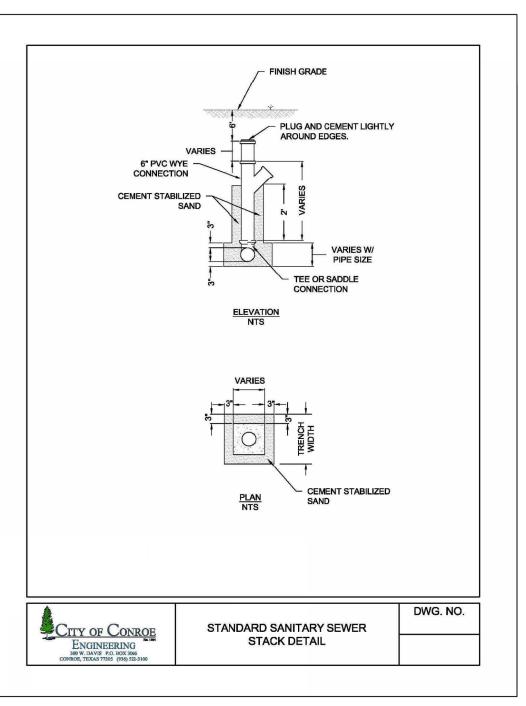

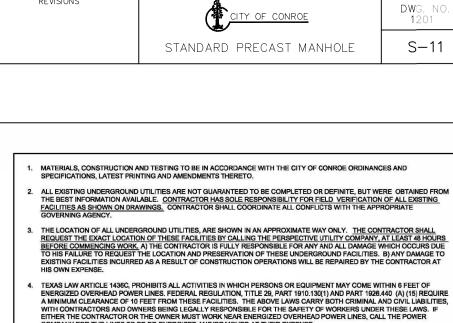

IDEQUATE DRAINAGE SHALL BE MAINTAINED AT ALL TIMES DURING CONSTRUCTION AND ANY DRAINAGE DITCH OR STRUCTURE DISTURBED DURING CONSTRUCTION SHALL BE RESTORED TO THE SATISFACTION OF THE PROJECT ENGINEER. ALL CONSTRUCTION RUNOFF SHALL COMPLY WITH STORM WATER MANAGEMENT FOR CONSTRUCTION ACTIVITIES AND THE IATIONAL POLLUTANT DISCHARGE ELIMINATION SYSTEM (NPDES) REQUIREMENTS.

EXISTING ROADS AND/OR RIGHT-OF-WAYS DISTURBED DURING CONSTRUCTION SHALL BE AS GOOD OR BETTER THAN THE CONDITION PRIOR TO STARTING THE WORK, UPON COMPLETION OF THE PROJECT.

11. AFTER ALL DISTURBED AREAS WITHIN THE CONSTRUCTION LIMITS HAVE BEEN COMPLETED TO THE LINES, GRADES, AND CROSS-SECTIONS SHOWN ON THE PLANS, HYDROMULCHING AND OR SOLID SODDING SHALL BE PERFORMED IN ACCORDANCE WITH THE REQUIREMENTS OF THE PLANS AND SPECIFICATIONS IN ORDER TO ESTABLISH ADEQUATE VEGETATION COVERAGE TO ELIMINATE EROSION. IF NO ACTIVITY HAS BEEN PERFORMED WITHIN THE DISTURBED CONSTRUCTION AREAS FOR 14 DAYS, THESE AREAS MUST BE HYDROMULCHED TO AVOID EROSION. IF NO PROVISION FOR PLANTING GRASS IS INCLUDED IN THE PLANS OR SPECIFICATIONS, THE MINIMUM REQUIREMENT FOR THIS ITEM WILL BE IN ACCORDANCE WITH THE TEXAS DEPARTMENT OF TRANSPORTATION STANDARD SPECIFICATIONS FOR "SODDING OR SEEDING FOR EROSION CONTROL."

CONTRACTOR / OWNER ARE TO OBTAIN ALL APPLICABLE PERMITS REQUIRED BY GOVERNING AUTHORITIES AT THEIR EXPENSI PRIOR TO COMMENCEMENT OF WORK.

CONTRACTOR / OWNER SHALL GIVE 48 HOURS NOTICE TO ALL AUTHORIZED AGENCIES IN CHARGE OF PRIVATE AND PUBLIC
UTILITIES PRIOR TO COMMENCEMENT OF WORK WITHIN THE CITY OR AUTHORIZED AGENCIES RIGHT-OF-WAYS OR EASEMENTS.

STANDARD CITY OF CONROE

GENERAL CONSTRUCTION

NOTES

0. ALL SAWCUTS OF EXISTING PAVED SURFACES SHALL BE FULL DEPTH SAWCUTS.


CITY OF CONROE


- 15. CONTRACTOR / OWNER SHALL PROVIDE ADEQUATE FLAGMEN, SIGNING, STRIPING AND WARNING TRAFFIC CONTROL DEVICES, DURING CONSTRUCTION IN ACCORDANCE WITH THE "TEXAS MANUAL ON UNIFORM TRAFFIC CONTROL". CONTRACTOR SHALL MAINTAIN AT LEAST ONE LANE OF TRAFFIC OPEN IN EACH DIRECTION DURING WORKING HOURS OR PROVIDE ALL-WEATHER DETOURS AROUND CONSTRUCTION SITE, PROVIDE PUBLIC NOTIFICATION, AND USE UNIFORMED POLICE OFFICERS TO CONTROL TRAFFIC, ESPECIALLY IN HEAVY TRAFFIC LOCATIONS. 6. CONTRACTOR / OWNER SHALL ERECT AND MAINTAIN BARRICADES TO ADEQUATELY PROTECT THE PAVEMENT, SIDEWALKS, DRIVEWAY, ROADWAY, AND PARKING LOTS FROM DAMAGED CAUSED BY ANIMALS OR FOOT TRAFFIC.THE CONTRACTOR SHALL HAVE PERSONNEL ON SITE UNTIL THE PAVEMENT HAS REACHED SUFFICIENT STRENGTH WHILE PAVEMENT IS CURING AND UNTIL REACHED 75% STRENGTH.
  - CONTRACTOR / OWNER SHALL BE RESPONSIBLE ON A DAILY BASIS FOR REMOVING MUD, DIRT, AND DEBRIS DEPOSITED ON EXISTING PAVEMENT DUE TO CONSTRUCTION ACTIVITY. ALL EXISTING STREETS AND ADJACENT PAVEMENT AREAS IMPACTED BY CONSTRUCTION ACTIVITY SHALL BE CLEANED USING A STREET SWEEPER. THIS ACTIVITY SHALL BE INCIDENTAL TO ALL OTHER ITEMS.
- I. THE CONTRACTOR / OWNER SHALL BE RESPONSIBLE FOR THE COORDINATION OF THEIR CONSTRUCTION ACTIVITIES WITH THE UTILITY COMPANIES AS TO THE RELOCATION OF THEIR FACILITIES, IF NEEDED. COMPANY FOR THE LINES TO BE DE-ENERGIZED AND/OR MOVED AT THEIR EXPENSE CONSTRUCTION SHALL COMPLY WITH THE LATEST OSHA REGULATIONS AND STATE OF TEXAS LAW CONCERNING TRENCHI AND SHORING. CONTRACTOR SHALL PROVIDE A TRENCH SAFETY SYSTEM TO MEET, AS A MINIMUM, THE REQUIREMENTS O THE CONTRACTOR / OWNER SHALL REMOVE ALL NON-PERMANENT SIGNS FROM THE R.O.W. AND/OR EASEMENT LIMITS, AND
  RETURN THEM TO THE SIGN OWNER FOR THEM TO HAVE PLACED AT THEIR EXPENSE ON PROPERTY OTHER THAN THAT STATED
  ABOVE UNLESS OTHERWISE SPECIFIED. OSHA SAFETY AND HEALTH REGULATION, PART 1926, SUB-PART P AS PUBLISHED IN THE FEDERAL REGISTER, VOLUME 54, NO. 209, DATED OCTOBER 31, 1989, AND CITY OF CONROE ORDINANCE NUMBER 1033-87, AND LATEST REVISIONS.
- THE CONTRACTOR / OWNER SHALL DETERMINE THE EXACT LOCATION AND DEPTHS OF ALL EXISTING UTILITIES BEFORE
  COMMENCING ANY WORK, AND SHALL BE RESPONSIBLE FOR ANY AND ALL DAMAGES CAUSED BY THEIR FAILURE TO EXACTLY
  LOCATE AND PRESERVE ALL UNDERGROUND UTILITIES. THE LOCATION OF EXISTING UTILITIES ON THESE PLANS ARE SHOWN IN
  AN APPROXIMATE LOCATION ONLY. DETAILS PREPARED BY THE CITY OF CONROE DO NOT EXTEND TO OR INCLUDE DESIGNS OR SYSTEMS PERTAINING TO THE SAFETY OF THE CONTRACTOR OR ITS EMPLOYEES, AGENTS, OR REPRESENTATIVES IN THE PERFORMANCE OF THE WORK. THE CONTRACTOR SHALL PREPARE OR OBTAIN THE APPROPRIATE SAFETY SYSTEMS, INCLIDING THE PLANS AND SPECIFICATIONS REQUIRED BY CHAPTER 758, SUBCHAPTER "C" OF THE TEXAS HEALTH AND SAFETY CODE.


**CITY OF CONROE** 

- I. THE CONTRACTOR / OWNER SHALL BE RESPONSIBLE FOR RELOCATING OR REPLACING ALL EXISTING FENCES INSIDE THE WORK ZONE, TO EXISTING OR BETTER CONDITION, EXCEPT FOR THOSE THAT FALL WITHIN A ROAD RIGHT-OF-WAY, IN WHICH THE FENCE SHALL BE BE RELOCATED OR REPLACED TO A DISTANCE OF ONE (1) FOOT OUTSIDE THAT RIGHT-OF-WAY. 3. EXISTING PAVEMENT, CURBS, SIDEWALKS AND DRIVEWAYS DAMAGED OR REMOVED DURING CONSTRUCTION SHALL BE REPLACED TO CITY OF CONROE STANDARDS. ALL ASPHALT AND CONCRETE DRIVEWAYS EXCAVATED DURING CONSTRUCTION SHALL BE BACKFILLED WITH CEMENT STABILIZED SAND (CSS) AND RETURNED TO EXISTING CONDITIONS. ALL STATE AND COUNTY HIGHWAY PAVEMENT AND RAILROAD RIGHT-OF-WAYS TO BE BORED ACCORDING TO THE RULES, REGULATIONS AND REQUIREMENTS FOR APPROVAL AND ACCEPTANCE BY SAID AGENCIES. SEE CITY OF CONROE "DESIGN MANUAL FOR WATER MAINS, SANITARY SEWERS, STORM DRAINAGE AND STREET PAVING".
  - ALL EQUIPMENT SHALL BE REMOVED FROM THE PROJECT SITE ONCE THE PROJECT IS COMPLETED, AS WELL AS, ALL REMAINING DEBRIS WITHIN PROJECT SHALL BE REMOVED AND PROPERLY DISPOSED OF AT AN APPROVED DISPOSAL SITE.

	ANSI, AND AWWA STANDARDS. IF THER	E IS A CONFLICT IN STANDARDS THE MOST STRINGENT SHALL GOVE
STANDARD CITY OF CONROE GENERAL CONSTRUCTION NOTES (CONTINUED)	ENGINEERING 300 W. DAVIS P.O. BOX 3066 CONROE, TEXAS 77305 (936) 522-3100	STANDARD CONSTRUCTION NOTES FOR SANITARY SEWER

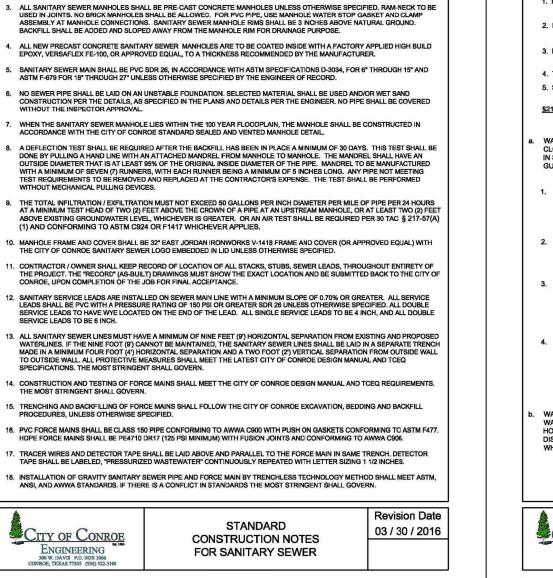


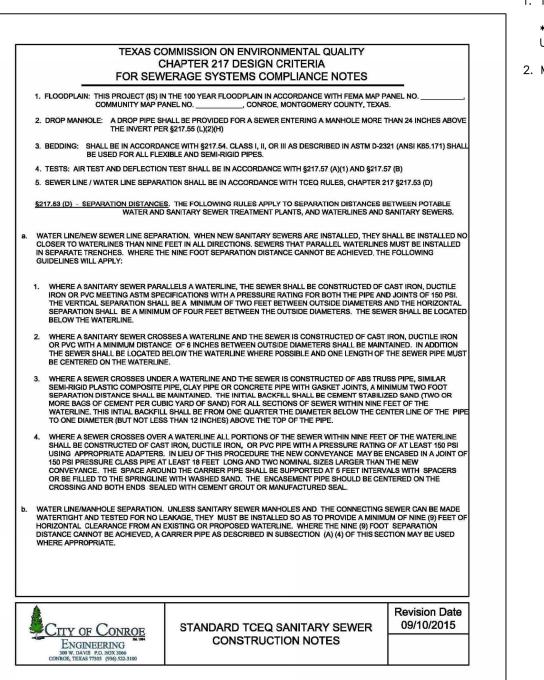

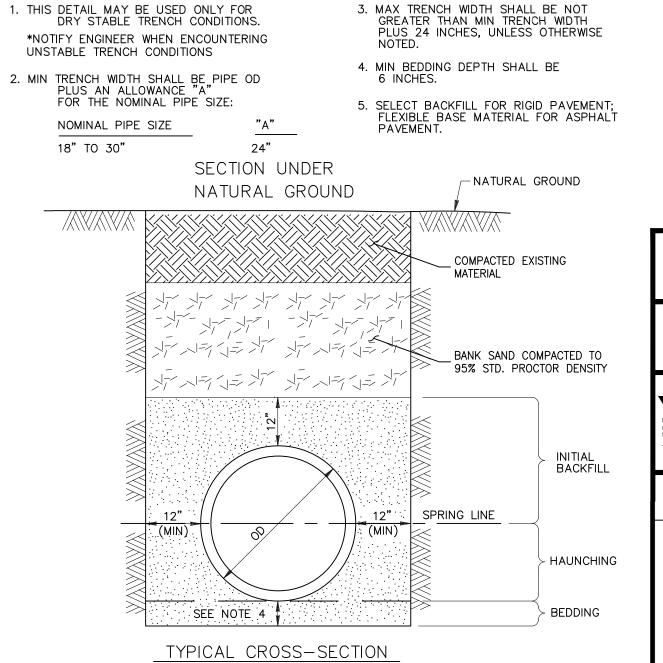


STORM SEWER BEDDING AND BACKFILL DETAIL


FOR DRY STABLE TRENCH

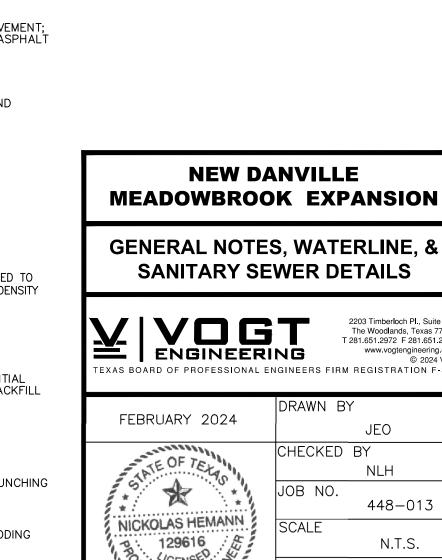



The Woodlands, Texas 773 T 281.651.2972 F 281.651.29 ENGINEERING www.vogtengineering.d EXAS BOARD OF PROFESSIONAL ENGINEERS FIRM REGISTRATION F-3 DRAWN BY FEBRUARY 2024 JEO CHECKED BY TE OF TELY NLH JOB NO. 448-013 NICKOLAS HEMANN N.T.S. ON CICENSEY SYONAL 2024.02.09 SHEET 16 OF 17 Nickolar Henam 13:28:18-06'00'


2203 Timberloch Pl., Suite 1

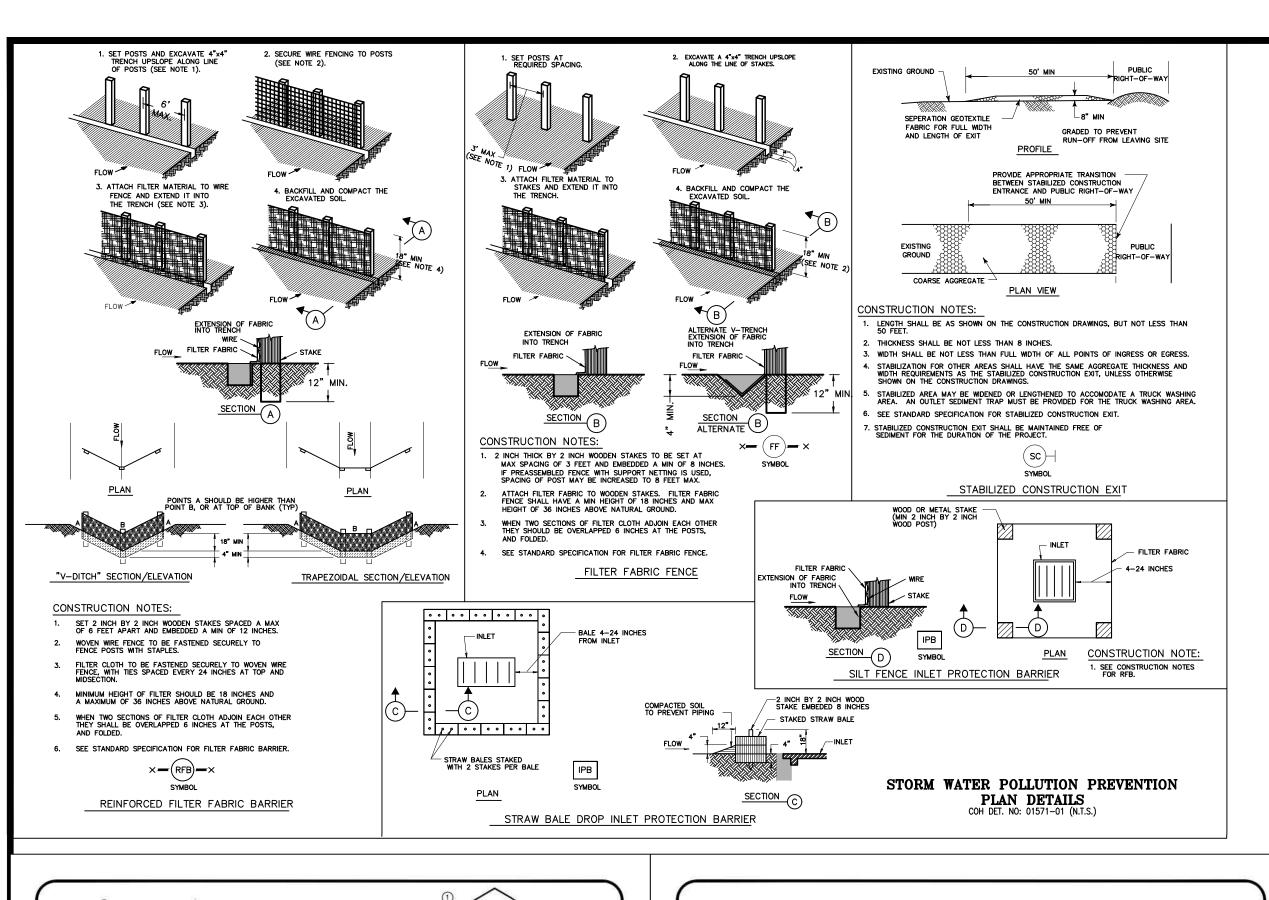


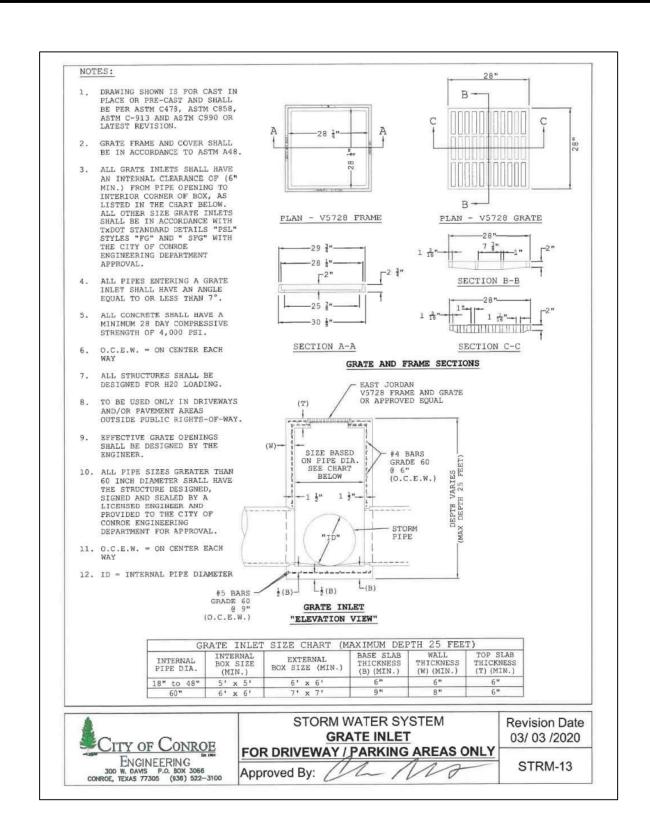

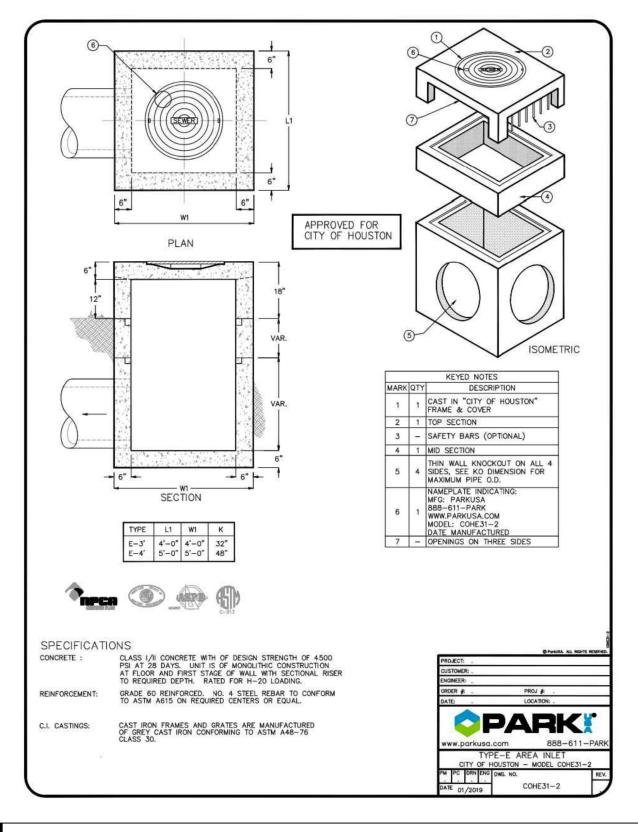


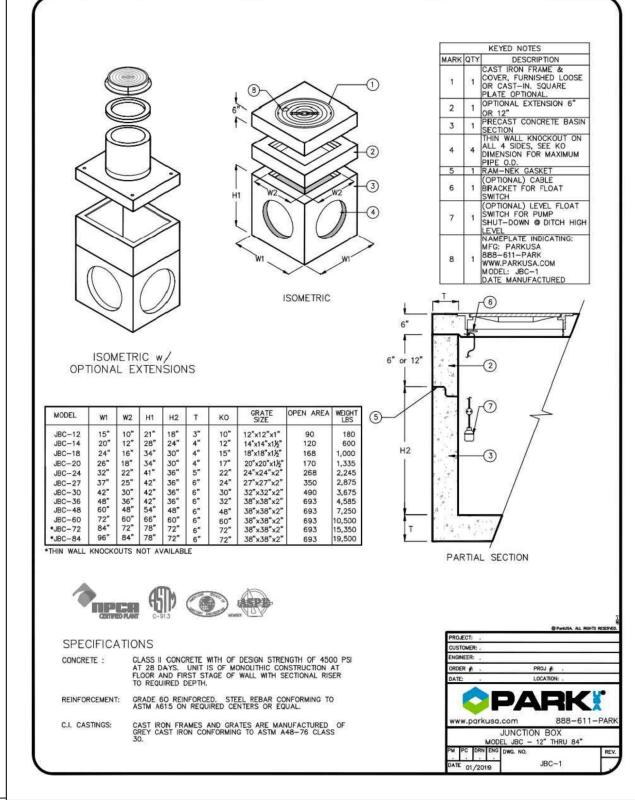


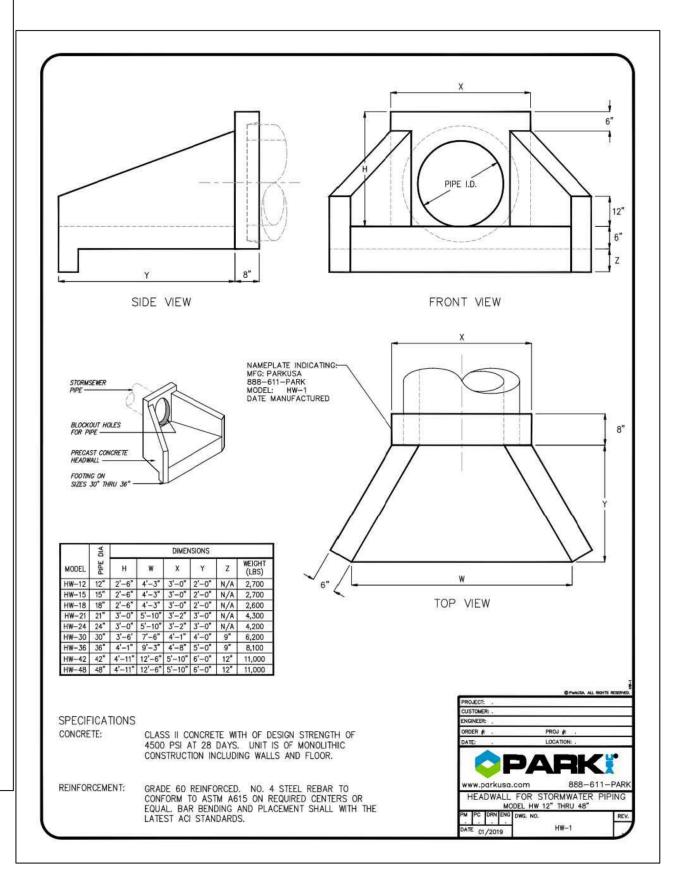

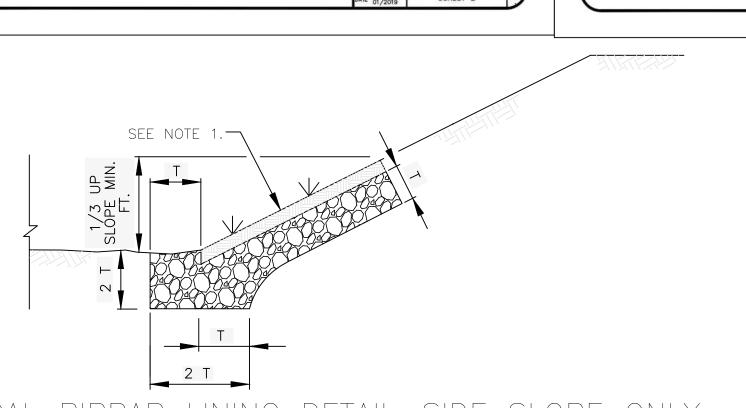




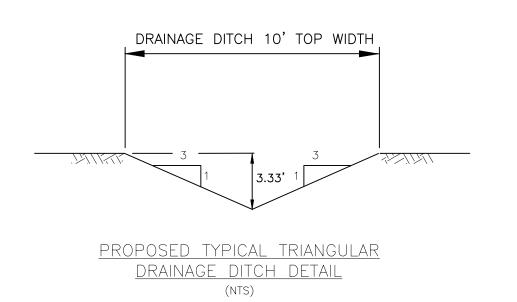

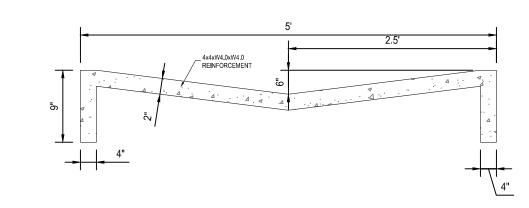

CONCRETE PILOT CHANNEL DETAIL

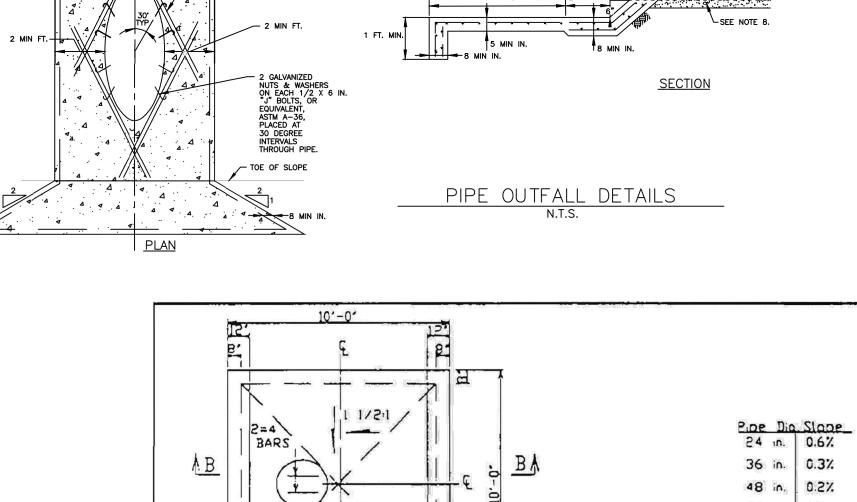


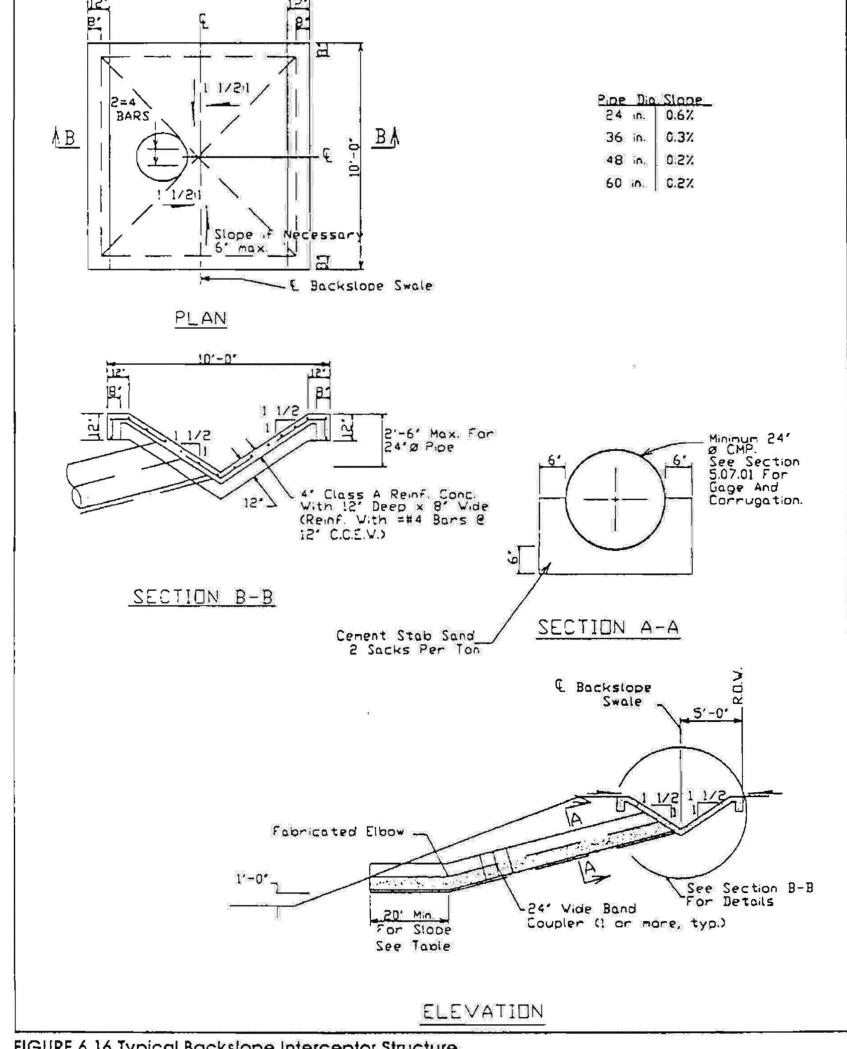


FIGURE 6.16 Typical Backslope Interceptor Structure



**STORM SEWER & DETENTION POND DETAILS** 

YOGT

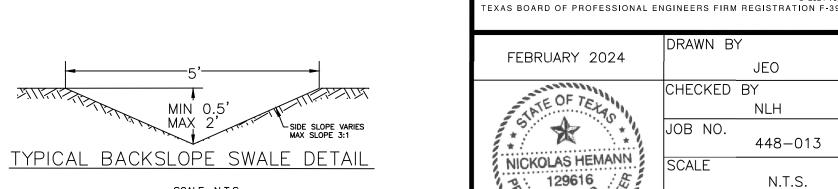

DRAWN BY JEO CHECKED BY NLH JOB NO. 448-013 N.T.S.

2203 Timberloch Pl., Suite 1

SCALE: N.T.S. MIN. FLOWLINE GRADIENT 0.20%

MIN 0.5'

STATE OF TELY NICKOLAS HEMANN 129616 Midealar Heman 13:28:44-06'00' SHEET 17 OF 17